



Current location of the original courtyard centerpiece, Tower of Masks by Anna Mahler, 1961



Gas

Coral Tree walk leading up to the entrance, note the paving



Outside view of entrances/exits



View of ticket window upon entry. The floor lighting guides people to the ticket window. Theater vestibule structure on the right Note the current floor pattern




View looking back towards the Murphy Sculpture Garden through the brise soleil. The original location of the Tower of Masks is in the center, now replaced by bench seating



(University Archives) depiction of the original flooring matching the exterior paving and location of the Tower of Masks



(University Archives) Tower of Masks upon installation. Note the wall coloring

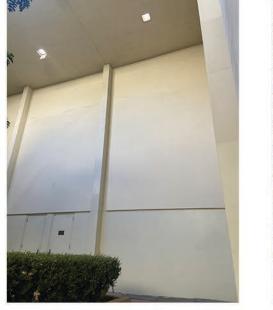



Current wall paint color




Current state of planted shrubs: covered in dirt/dust



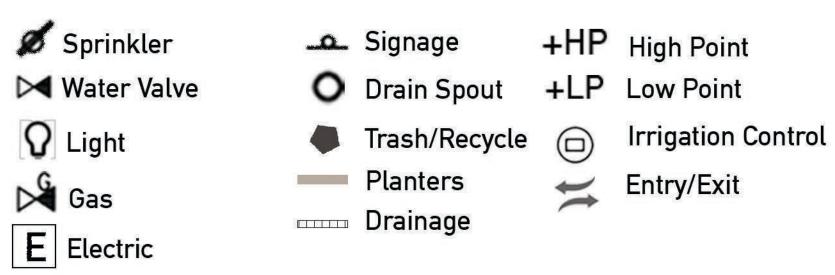


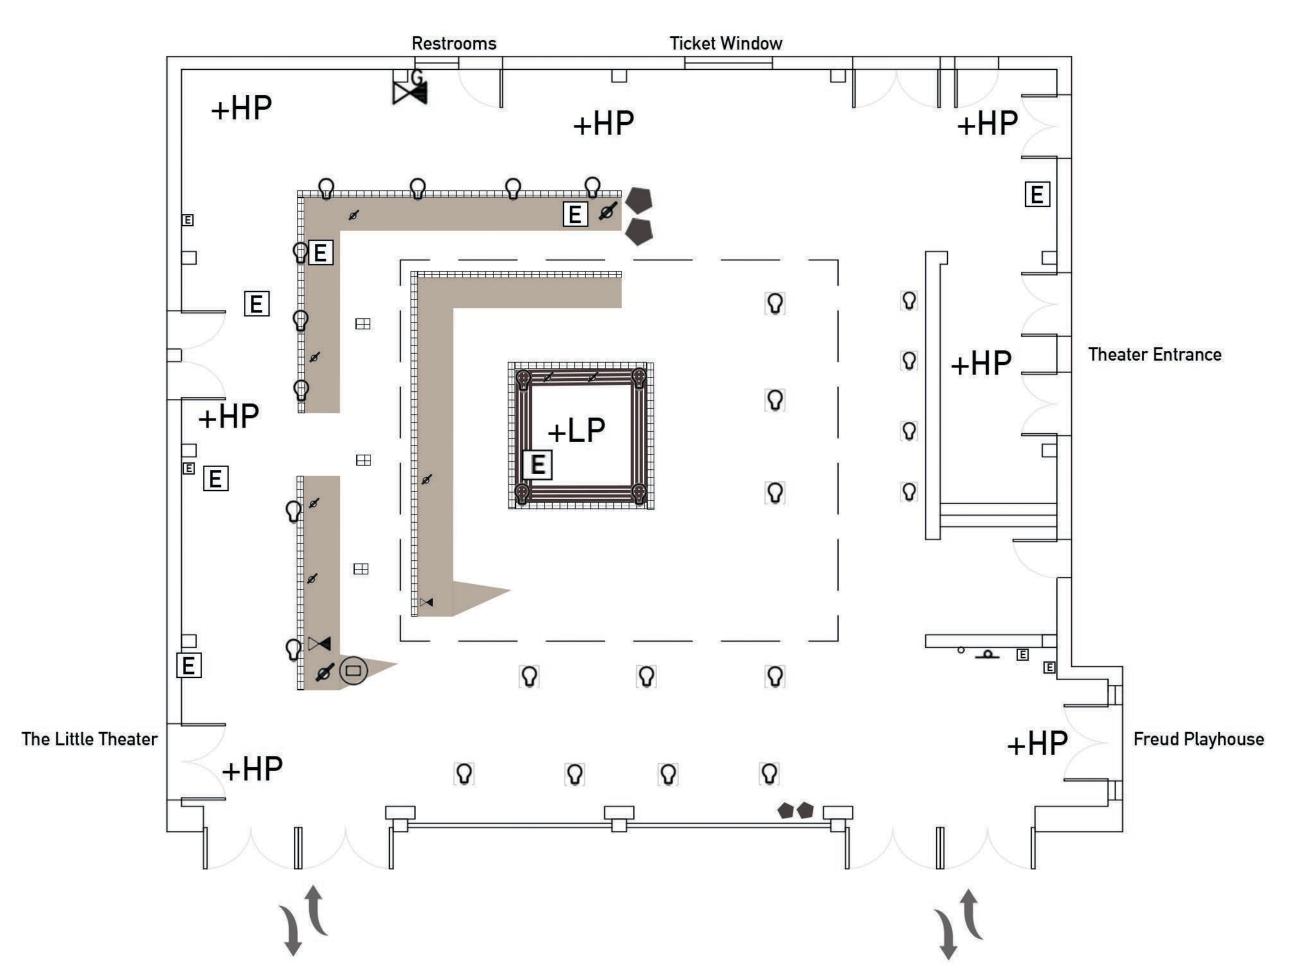


Site Inventory Legend: Natural Elements

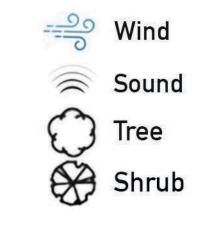

USDA Hardiness Zone 10b Average Precipitation 1 in. (monthly) Sun Path

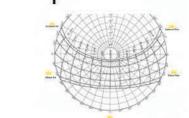

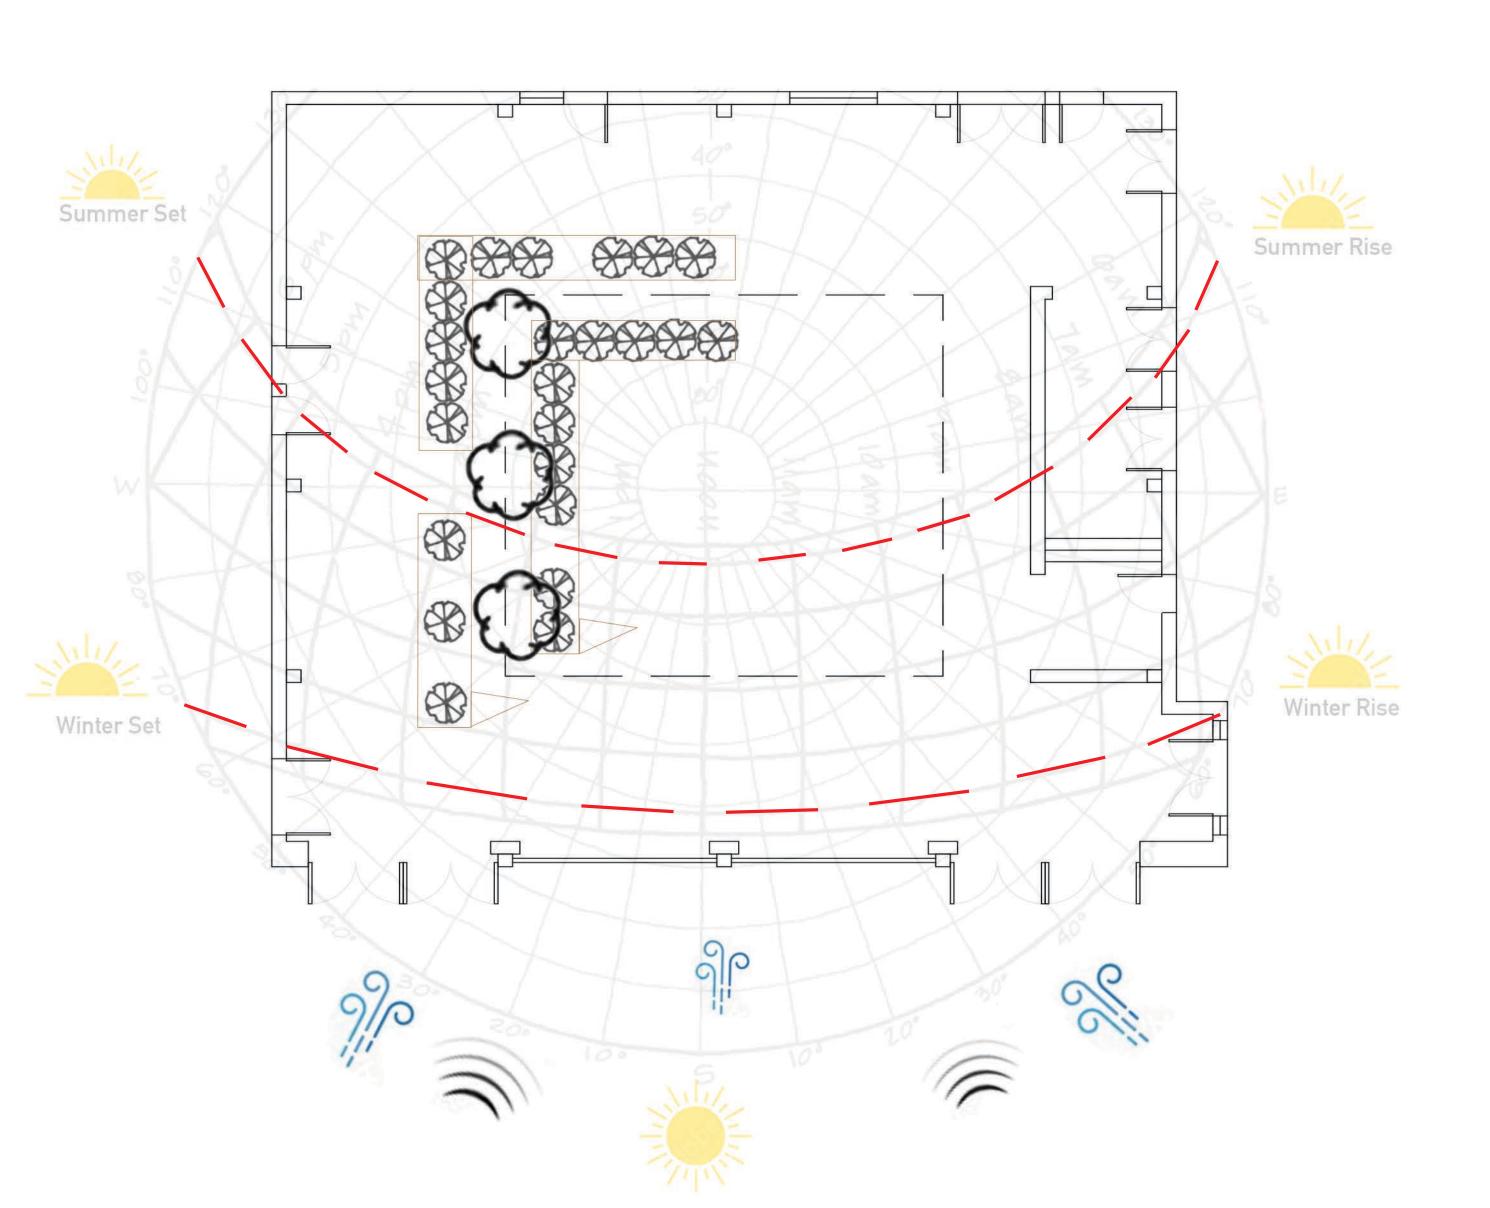

Mia Skolnik

LD1

INSTRUCTOR: Steven Chavez

SITE NAME AND ADDRESS: UCLA Courtyard of Theaters: Macgowan

245 Charles E Young Dr Los Angelese, CA

DRAWING TITLE:

Site Inventory





DRAWING NOTES:


This site inventory drawing consists of two elements an inventory of the build elements and of the natural elements affecting the site. UCLA's Courtyard of Theaters at Macgowan Hall is a 60x60 sqft site tucked behind a two-story brise soleil with an open roof in the center. Currently, there are three rectangular planter beds on the west side of the Floor lights guide patrons to the ticket window on the north wall across a floor that slopes from the outer walls down towards the center where drainage can be found around the central bench, as well as around the planters. There are electrical outlets on each of the four walls as well as in some of the planter beds and under the bench. Irrigation and irrigation controls

are found in the planter beds. A gas shutoff valve is located near the bathroom on the north wall.

The brise soleil acts as a barrier between the courtyard and the open space of the Murphey Sculpture Garden, providing protection from wind, summer heat, and noise, while still allowing for filtered light, fresh air, and the muted sounds of the nearby fountain to reach into the space from the south. The inward sloping of the ground inside the courtyard is necessary to allow for drainage of rainwater that enters the space through the open roof (about 12 inches of rain per year). There are three trees located on the site, each reaching towards the small roof opening, causing them to lean as they grow. The shrubs in the planters are sparse in some areas and covered in a thick layer of dit. It seems that wind can easily enter the space but not pass through,

allowing dirt and debris to collect and settle.

NORTH ARROW:

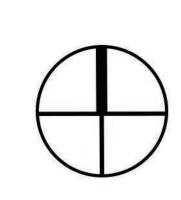

1/8" = 1'-0"

1 of 5 L-1



vertical space; dark







tall echoing walls

Missed potential of rain water

SITE CONSTRAINTS















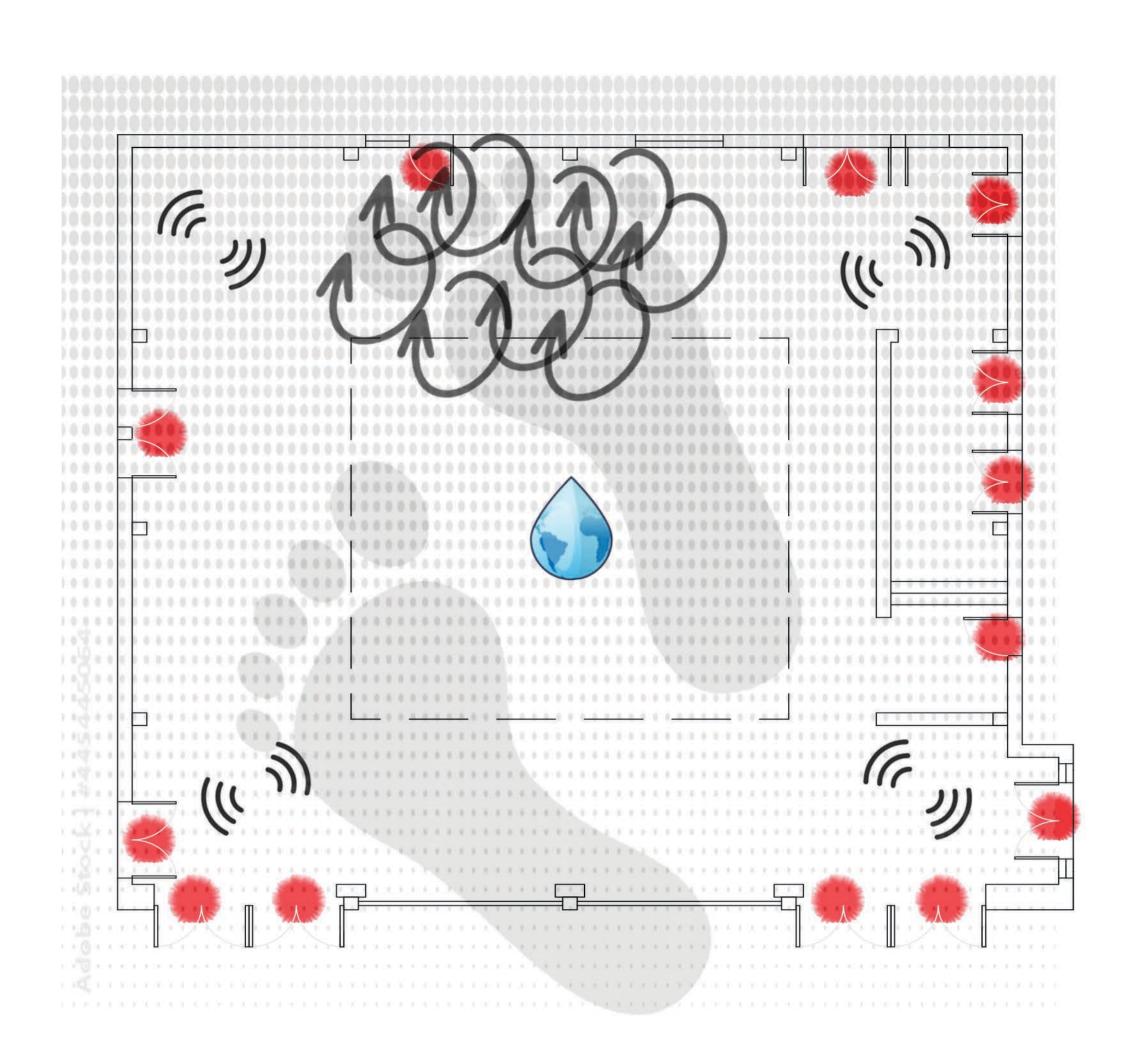



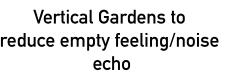







Sunken garden area for gathering



runoff filtering/waste reduction



Glass colored panels to add warmth

SITE OPPORTUNITIES

Sunken gathering area/upper level/catwalk Retractable Roof



Vertical/Vestibule Garden




Warm Materials Fireplace





Rain Garden

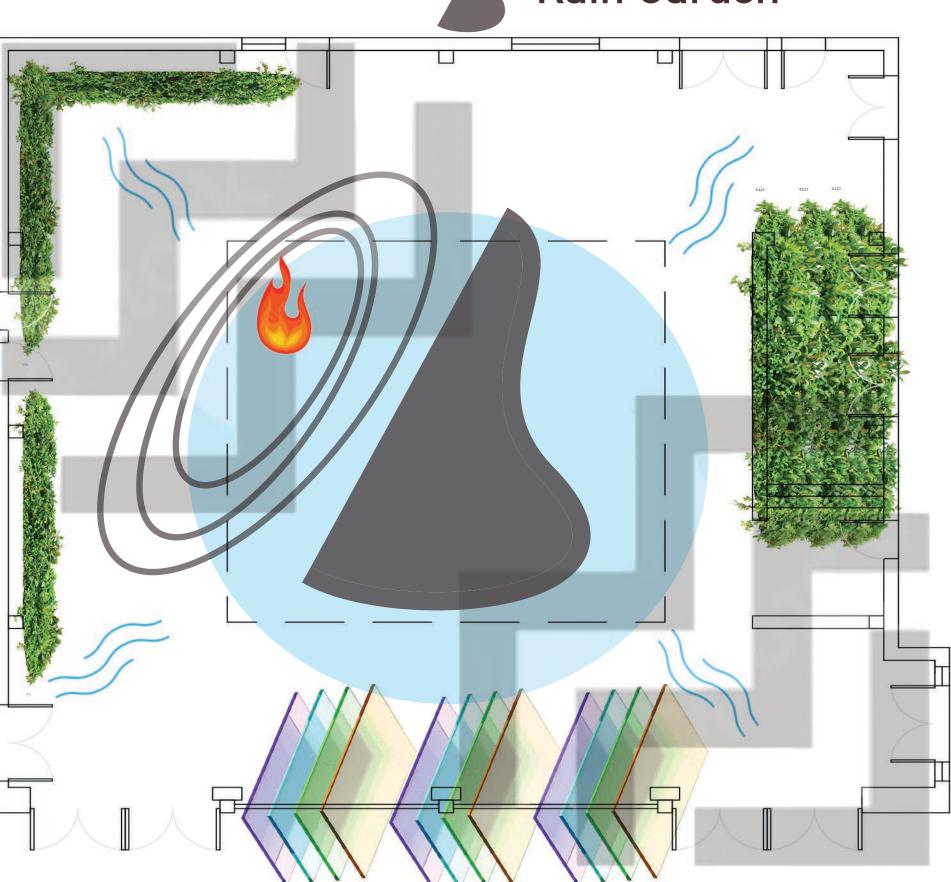

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SITE NAME AND ADDRESS:

UCLA Courtyard of Theaters: Macgowan 245 Charles E Young Dr Los Angelese, CA

PRAWING TITLE:

Site Analysis



- a small footprint: the usable space is not

winter months): the small roof opening and

· wind eddying: the wind can enter and get trapped, creating an eddying effect in the

empty, tall space - unused rainwater runoff echo/emptiness: the tall vertical and

empty space leads to a cavernous/cold empty feeling when inside - the location of the doors and door swings cannot be moved

However, there are some opportunities to address the constraints above, including

(but not limited to): - building up or down (or both): adding a sunken gathering area and/or a second


- widening the roof and adding a retractable feature to keep it warmer in the winter and protect against wind eddying

- a vertical garden on the walls can be used to make the space more inviting and reduce

- using warm materials, such as colored glass and wood accents - redirecting the rainwater runoff to be collected in a cistern that can be used for the restrooms and watering the courtyard

garden, as well as possibly the sculpture

NORTH ARROW:

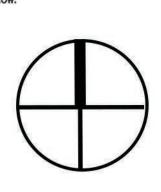



1/8 " = 1'0"

L-2

Stage Whisper Grove

Curtain Call Plaza

Encore Oasis

Sustainability through material reuse:

- re-arrange existing planters
- repurpose bench materials
- keep the brise soleil
- re-arrange the trees
- keep ceiling as-is


Additions:

- Vertical gardens to reduce echo, add warmth, and address wind eddying
- Vines on trellis for vestibule
- Conversational seating area
- Cistern under seating area that recycles water to restroom, water feature on vestibule wall and fountain in main garden
- Cafe in place of ticket booth to add economical value
- Movable chairs/tables and fixed countertop
- Addition of glass panels to reduce wind effect and add warmth, color
- Bring the Coral Tree Walk brick pattern inside for continuity







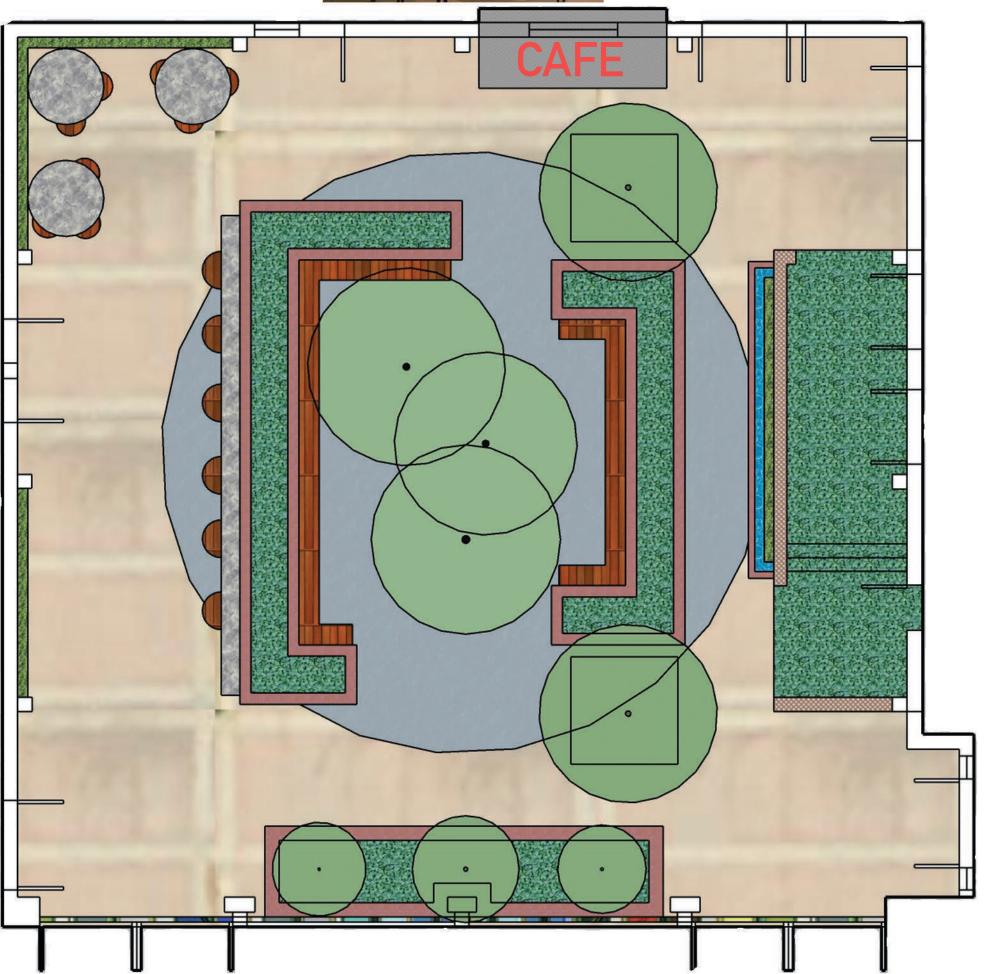

Sustainability through material reuse:

- repurpose bench materials
- keep the brise soleil
- keep existing trees


Additions:

- Vertical gardens to reduce echo, add warmth, and address wind eddying
- Vines on trellis for vestibule
- Conversational sunken seating area with rain garden
- Cistern under seating area that recycles rain water to restroom
- Cafe in place of ticket booth to add economical value
- Movable chairs/tables
- Addition of glass panels to reduce wind effect and add warmth, color
- Bring the Coral Tree Walk brick pattern inside for continuity
- Enlarge the roof area with glass atrium ceiling
- Planters doubling as seating







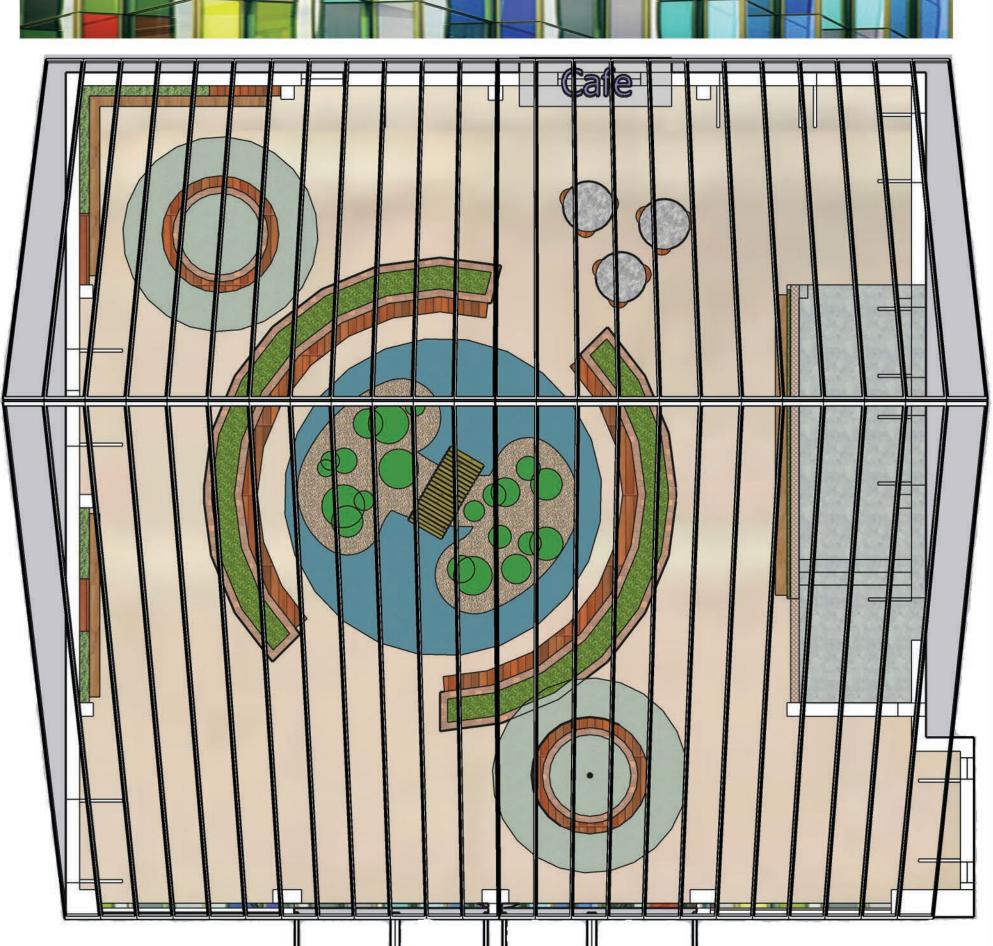

Material reuse:

- Brise soleil
- Trees

Additions:

- Open brise soleil in center to bring in the garden
- Vertical gardens
- Vines/trellis for vestibule
- Colored glass paneling inside brise soleil
- Corner seating area with firepit
- Cistern under seating area to recycle rainwater

- Cafe in place of ticket booth
- Flooring to match Coral Tree Walk
- Retractable enlarged atrium ceiling
- Water wall/feature on vestibule
- Tree bridge walk through middle of courtyard

- Sunken seating on sides of tree bridge walk

- Reflection pools in sunken seating areas

Design Concepts

Mia Skolnik

Steven Chavez

UCLA Courtyard of


Los Angelese, CA


Theaters: Macgowan


245 Charles E Young Dr

SITE NAME AND ADDRESS:

LD1

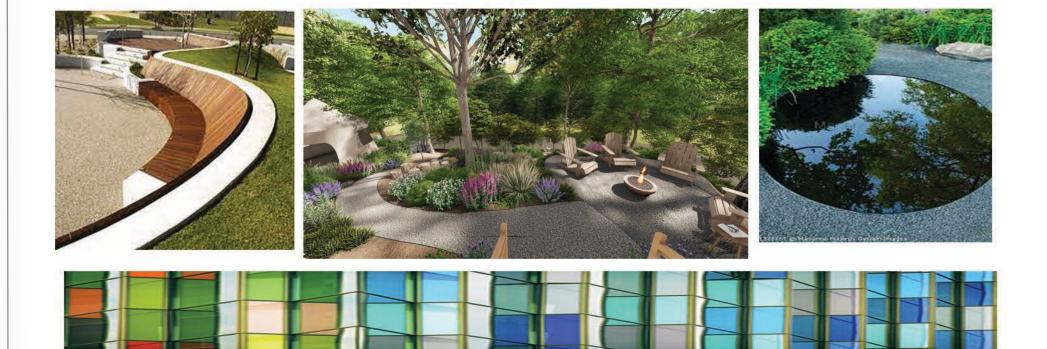

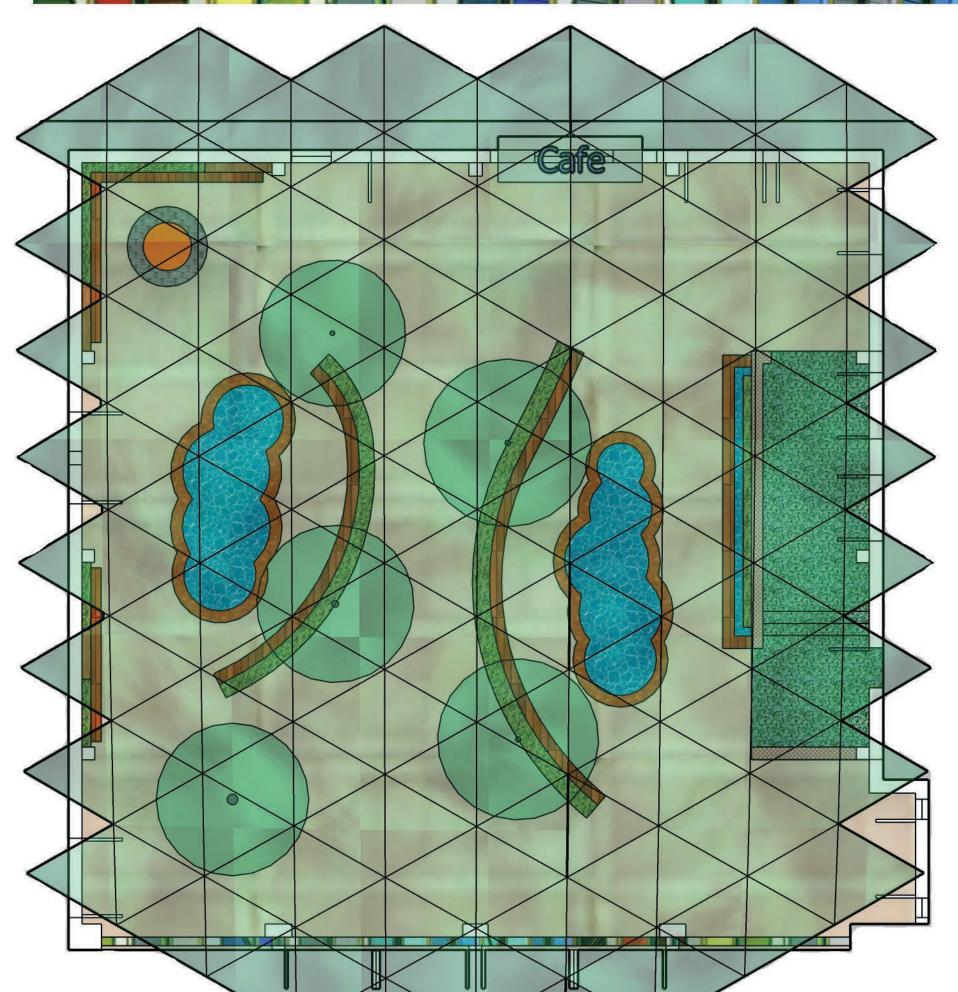

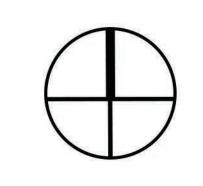


3 of 5


ENCORE OASIS


at Macgowan Hall





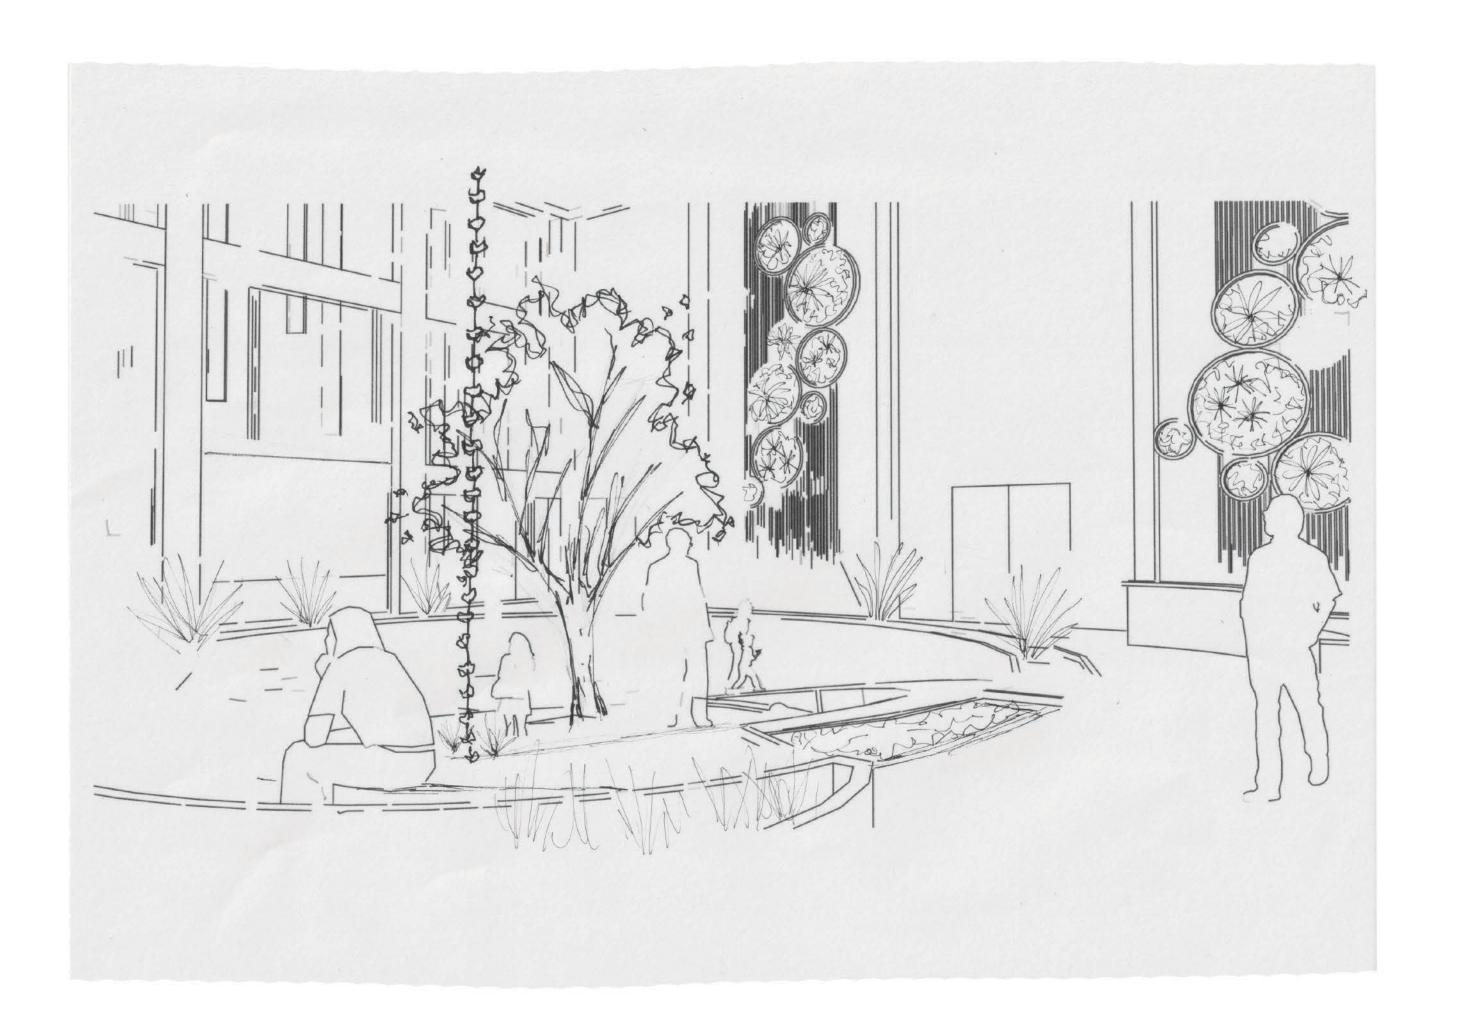

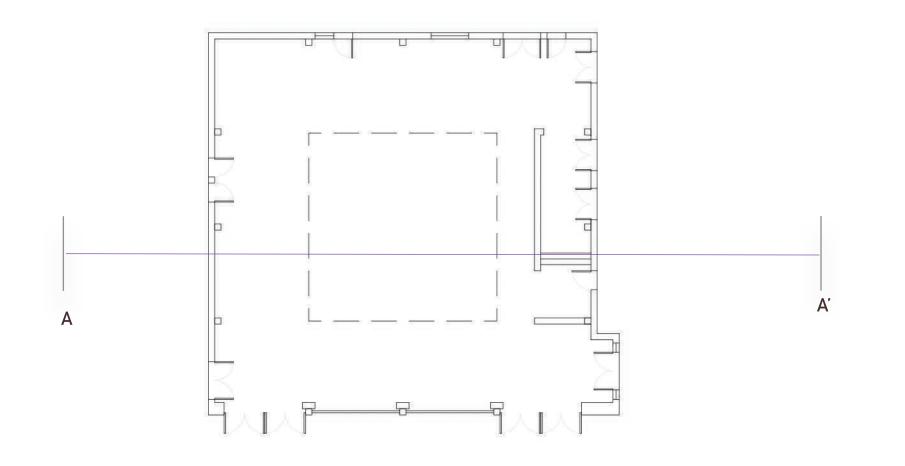

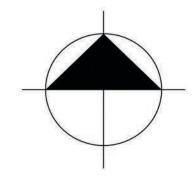

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Section & Perspective



DESIGN STATEMENT

The Encore Oasis includes a sunken rain garden where folks can gather, relax, and explore. The butterfly roof has no glass covering above the rain garden and the shape of the roof allows for water to flow directly into the garden below. Underneath the rain garden is a cistern used to collect rainwater that can be repurposed for irrigation and use in the restrooms.

Colored glass paneling on the brise soleil serve to reduce the wind eddying effect and give a colorful playfullness to the

The central entry in the brise soleil will remain open to connect the courtyard to the main sculpture garden as well as give passersby a peak into the space that will invite them to explore further.

The cafe will serve a revenue generating function to help maintain the courtyard.


1/4 " = 1'0"


SHEET NUMBER IN SET:

5 of 5

ENCORE OASIS


at Macgowan Hall

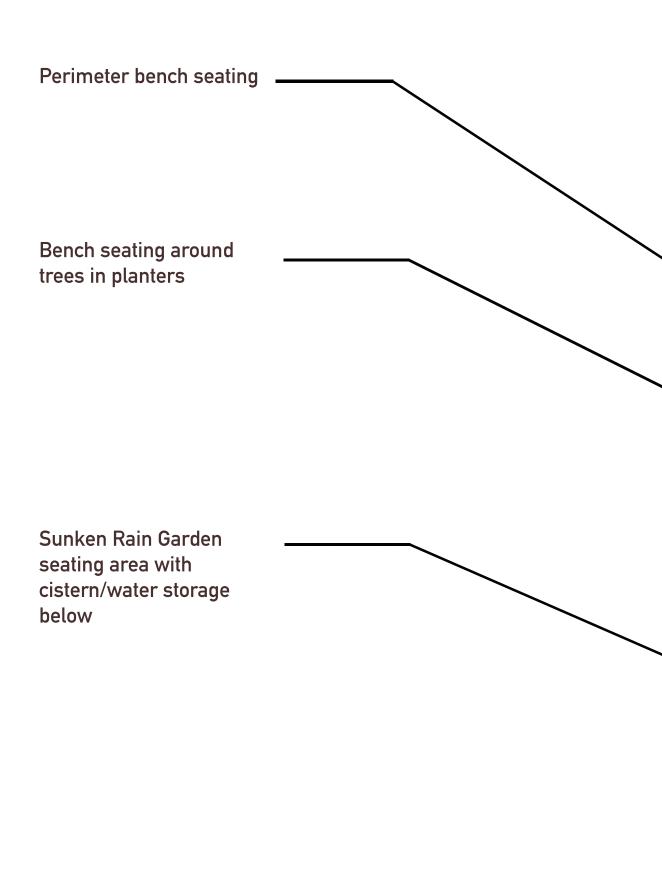

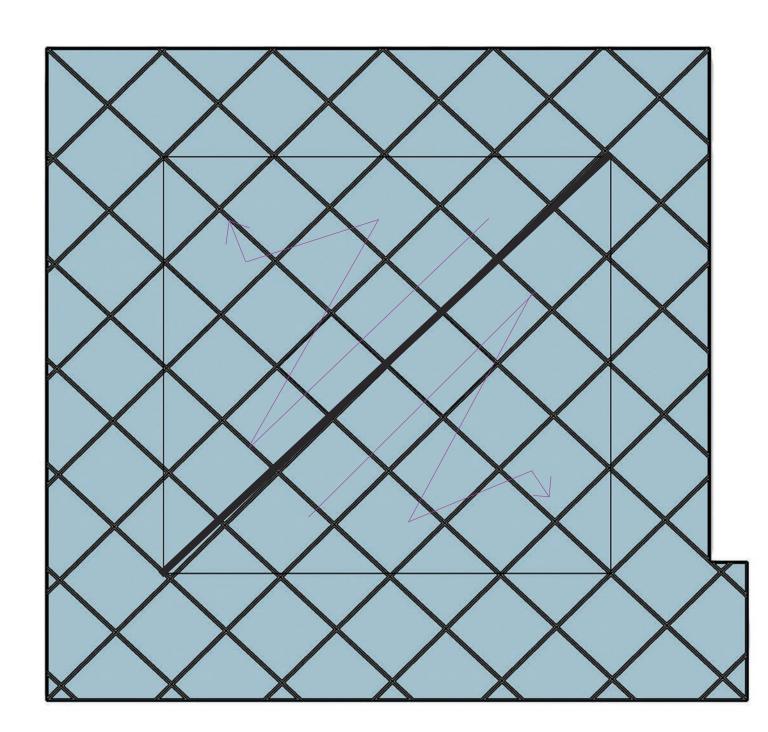

Retractable Glass Atrium Roof Plan

The roof will be replaced with a glass atrium that retracts diagonally from the center. Rain chains will be placed on the diagonal support beam to allow rain collection to the rocky rain garden bed below.

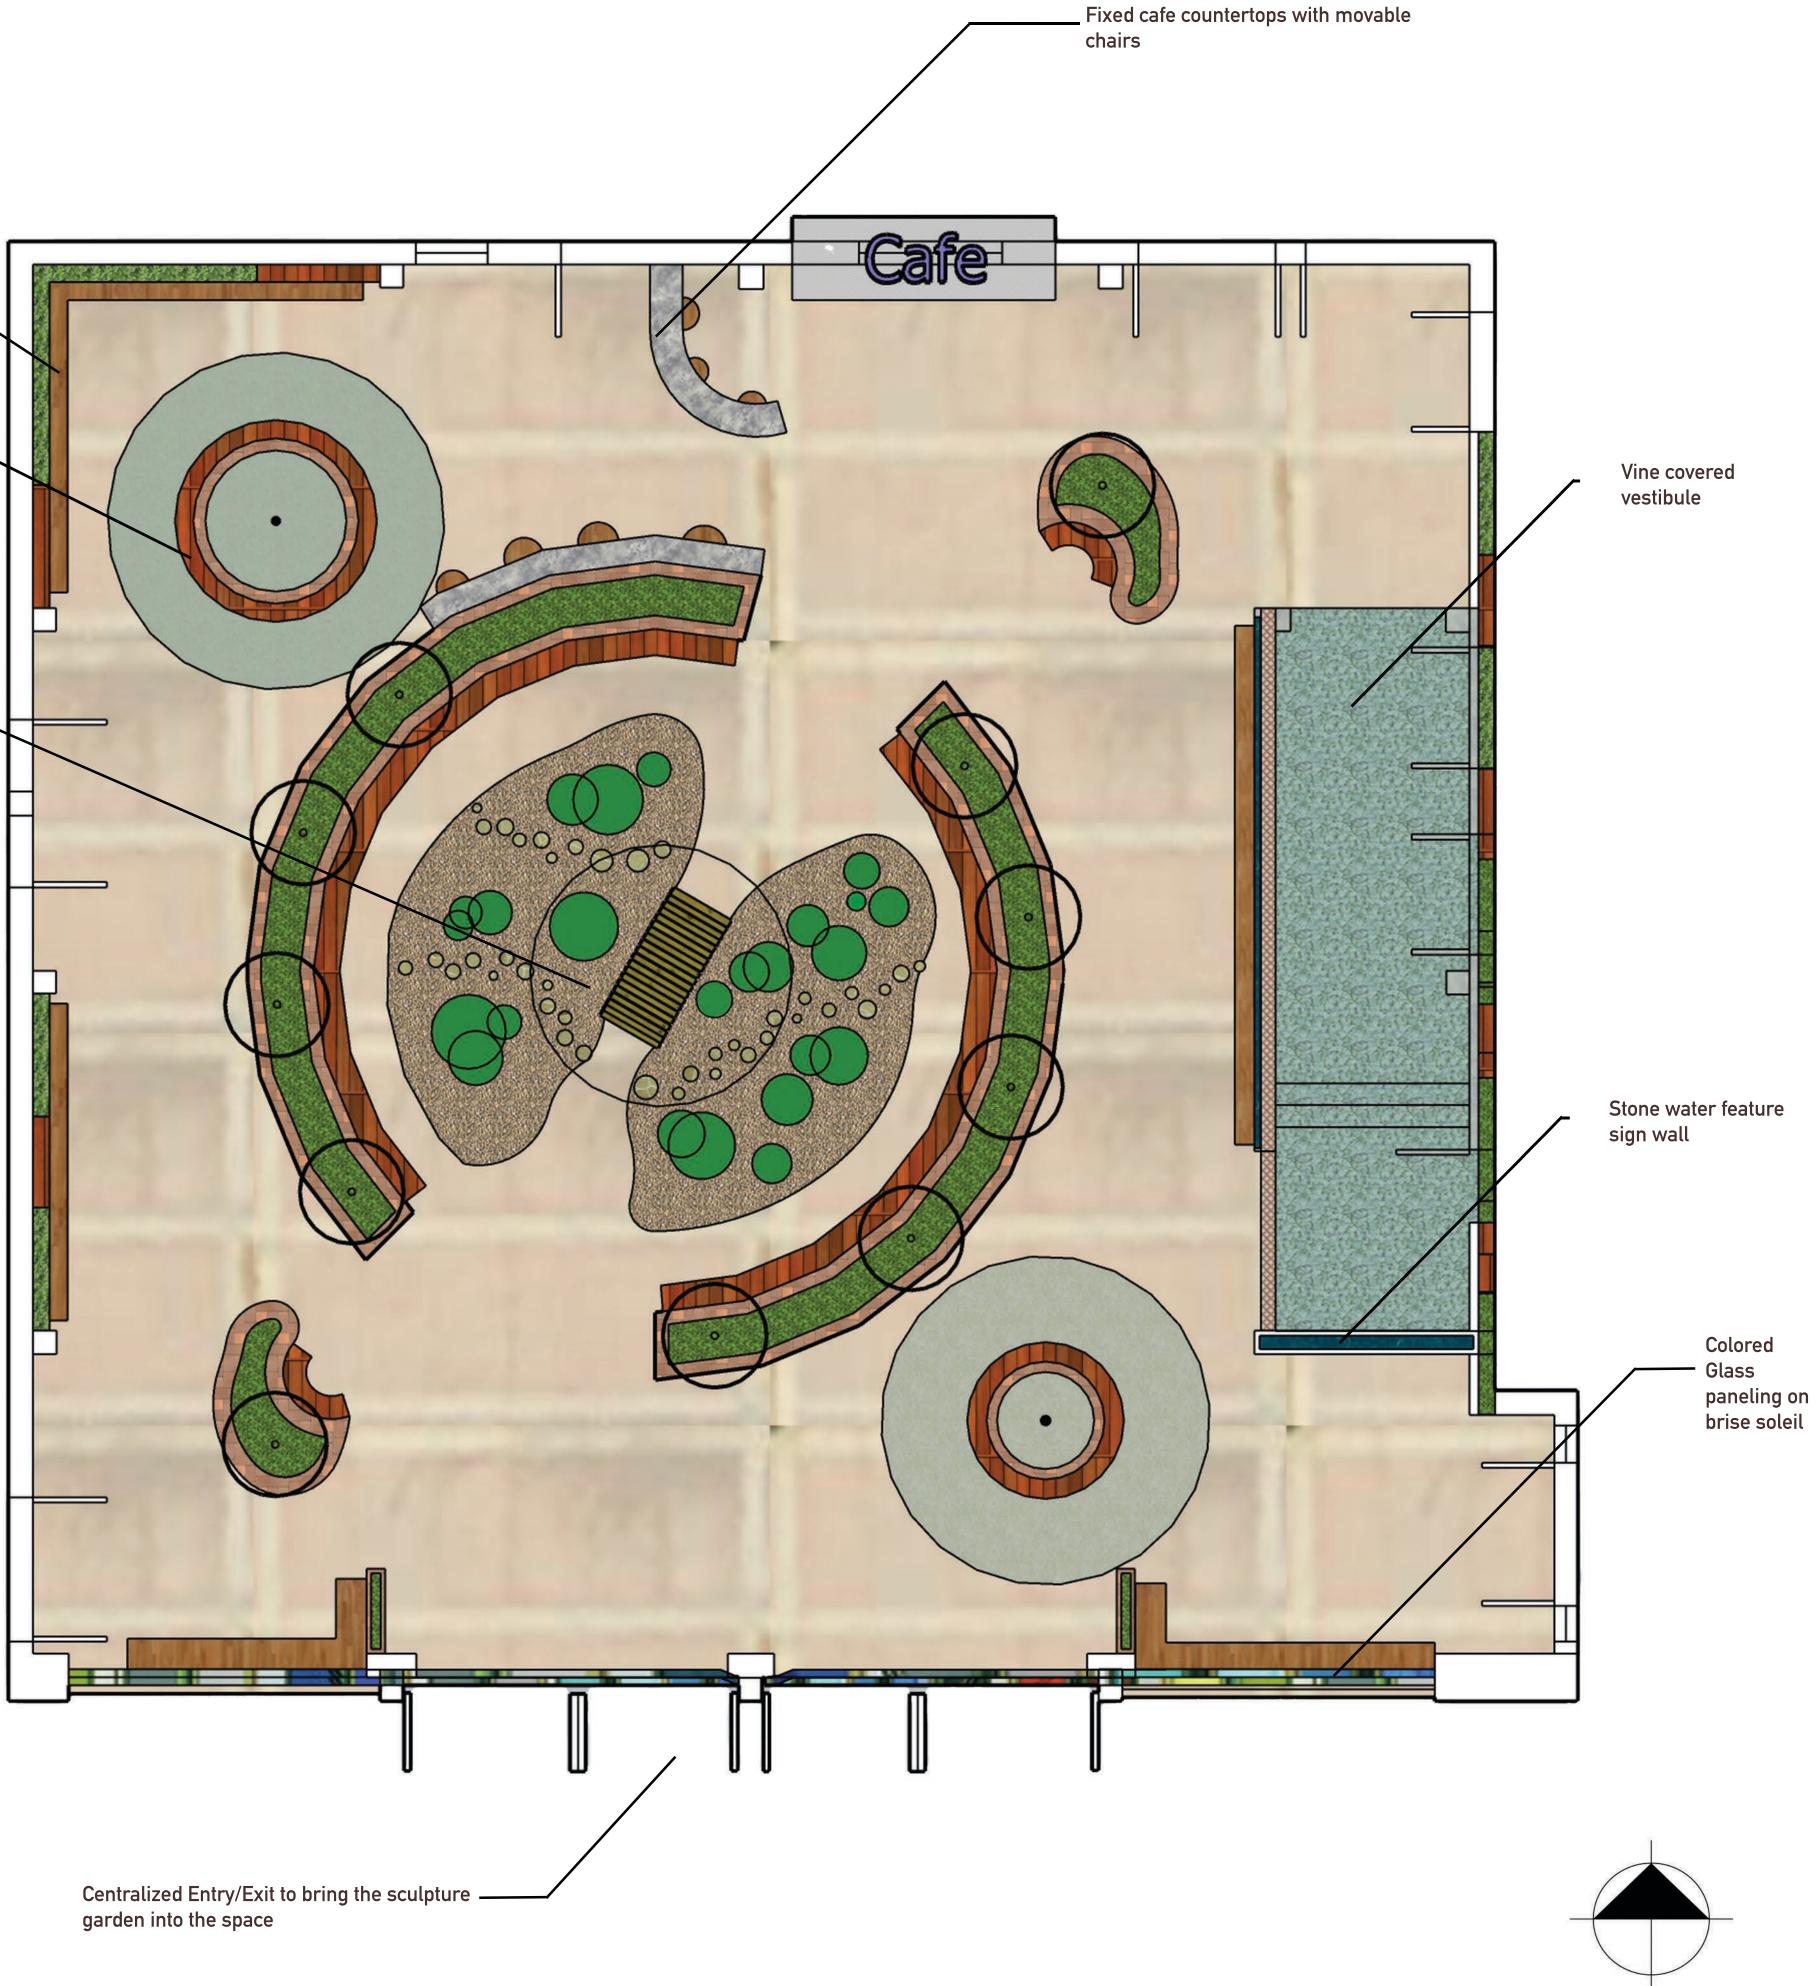

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LD1

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SITE NAME AND ADDRESS:

UCLA Courtyard of Theaters: Macgowan Hall 245 Charles E Young Dr Los Angelese, CA


DRAWING TITLE

Final Site Plan



DESIGN STATEMENT

The Encore Oasis provides a space to discover and enjoy with a cafe replacing the existing ticket booth and a sunken seating rain garden area. The glass atrium roof brings in the sun and with retracting functionality allows rain to enter which will be collected in an underground cistern and will be recycled for use in the restrooms and irrigation. The rain garden includes a bridge and wandering paths through California native and native adaptive plants that tolerate dry conditions. The entry/exit doors will be moved to the center to connect the space to the Coral Tree Walk and sculpture garden. Fixed permiter and planters with benches provide plenty of seating choices with different views and experiences in each area of the courtyard. The courtyard floor will be fashioned after the Coral Tree Walk. The vestibule will be a vine-covered trellis and will serve to block noise and light when leaving the theater. The tall courtyard walls will be paneled in vertical wood slats and vertical gardens.

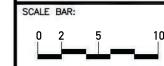

1/4 " = 1'0"

SHEET NUMBER: SHEET NUMBER I

