
Macgowan Courtyard

CAL MINGIONE

LANDSCAPE DESIGN I | UCLAX | WINTER 2021

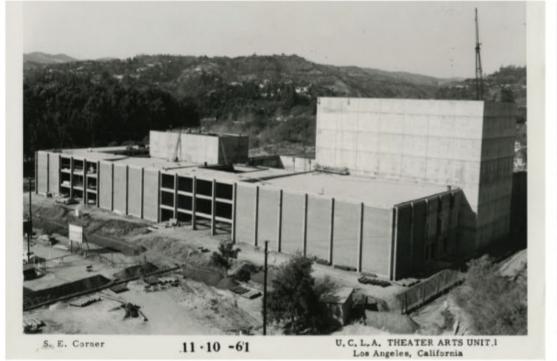














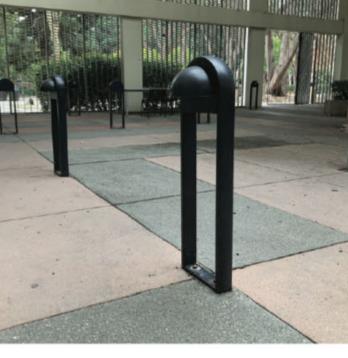

TYPICAL GROUND LIGHT

MACGOWAN HALL (1961)

TOWER OF MASKS (1961)

VIEW OF SITE FROM CORAL TREE WALK

SHADOW CAST BY BRISE-SOLEIL

CENTER BENCH AND PLANTER AREAS

EXISTING PEPPERTREES GROWING TOWARDS WALL TREATMENT AT TICKET WINDOW CIELING OPENNING

LEGEND

PLANTER AREA

DRAINAGE GRATES

DOWNSPOUT

CIELING GRATE

DIRECTION OF WATER FLOW

W WATER SPICKET / SPRINKLER CONTROL

SPRINKLER HEAD

+ KP HIGH POINT

+LP LOW POINT


ELECTRICAL/UTILITY BOX


→ OUTLET


GROUND LIGHT


CIELING LIGHT


WALL LIGHT (PLANTER MOUNTED)

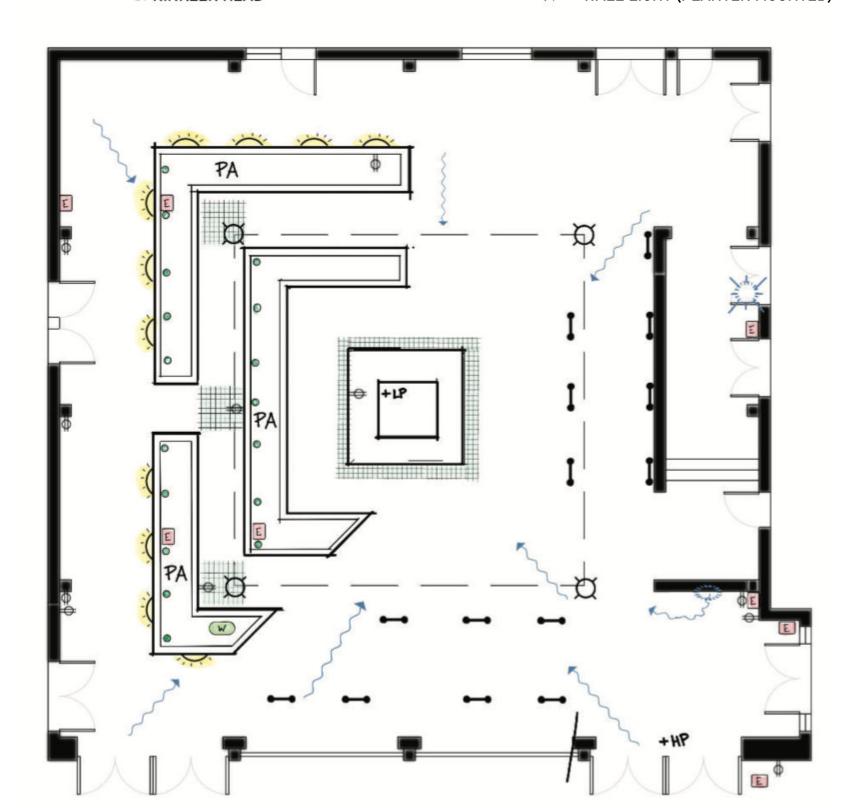

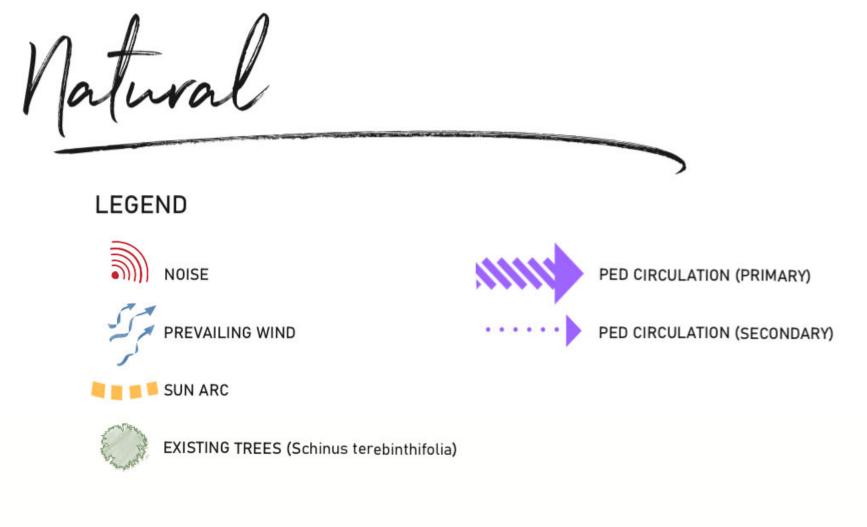

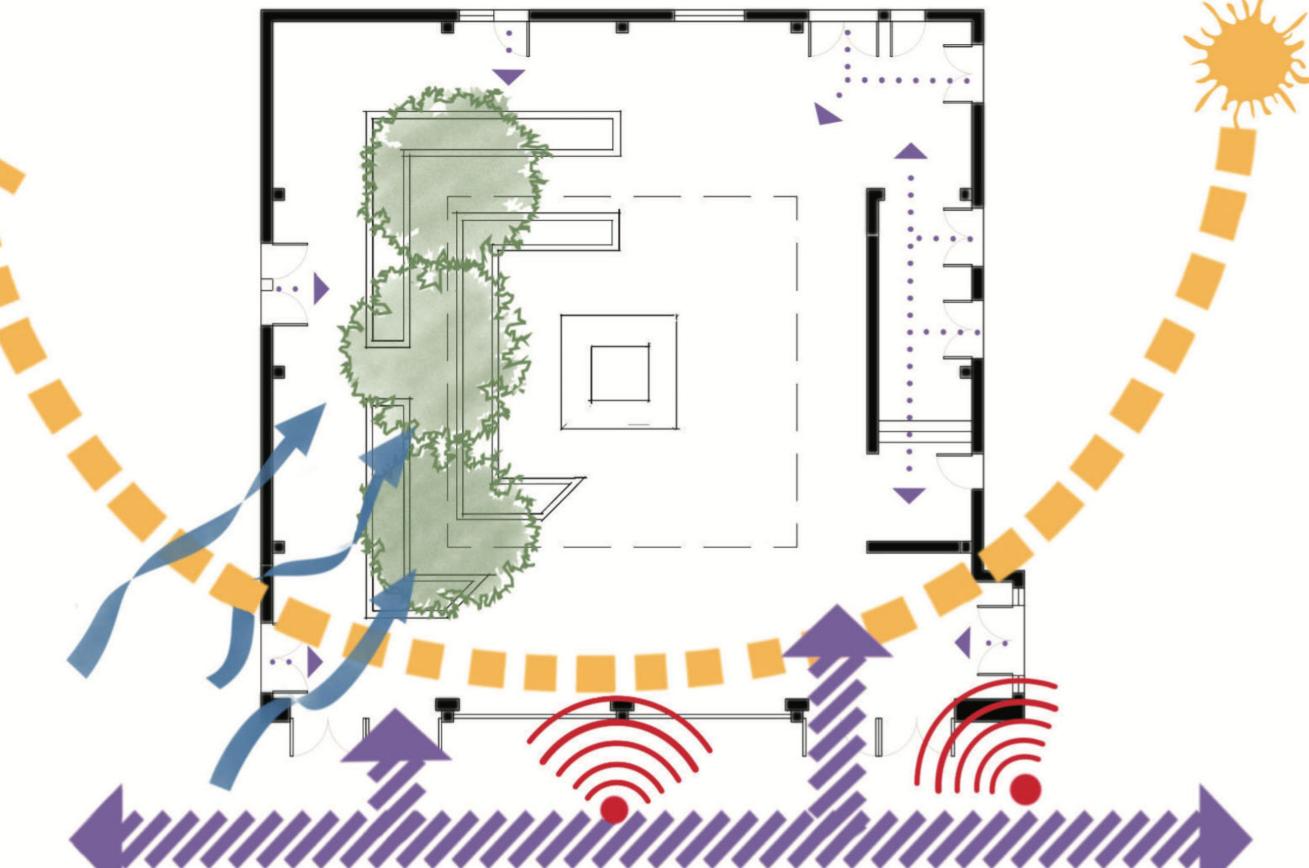

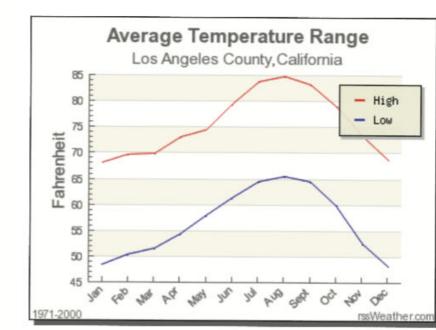

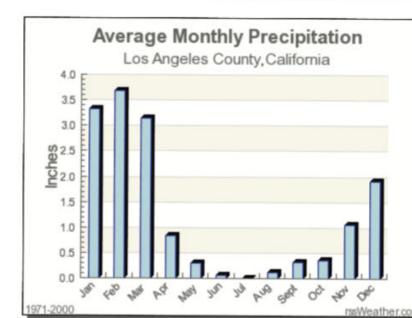






LANDSCAPE DESIGN 1

STEVEN CHAVEZ

SITE NAME AND ADDRESS:

MACGOWAN HALL COURTYARD 245 CHARLES E YOUNG DR. LOS ANGELES, CA 90095

DRAWING TITLE: SITE INVENTORY

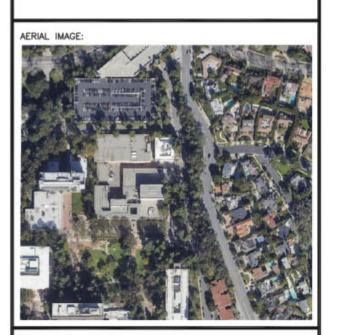

DRAWING NOTES:




1/8" = 1'0" 1 OF 6

Constraints => Opportunities




SUN

THE SITE RECIEVES MINIMAL DIRECT SUNLIGHT. THE 30 FT. TALL WALLS AND ROOF OVERHANG CAST STRONG SHADOWS, CREATING CONSTRAINTS ON PLANTINGS.

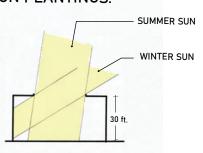




PERMEABLE SOUTH ELEVATION AND OPEN ROOF, IN COMBINATION WITH THE TALL, SOLID THREE COURTYARD EDGES CHANNEL PREVAILING WIND INTO COURTYARD AND CREATE EDDIES

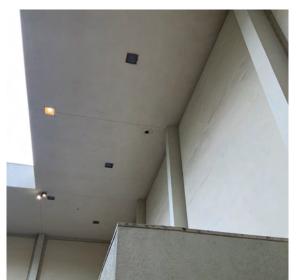

NOISE

TALL, SOLID WALLS AND ROOF OVERHANG CAPTURE AND REFLECT NOISE, CREATE ACOUSTICAL CONSTRAINTS AT THE SITE, INCLUDING NOTICEABLE ECHO.

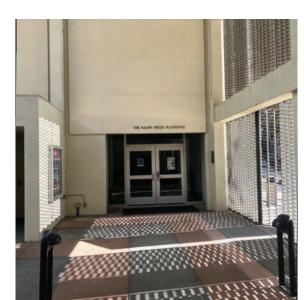


COURTYARD SIZE & DOORS

THE SITE HAS LIMITED FUNCTIONAL/ PROGRAMMABLE SPACE GIVEN THE EXISTING DOOR LOCATIONS AND THE SPECIFIC AND FIXED ADJACENT USES.




DRAINAGE

INVERTED DRAINAGE RESULTS IN FINISHED GRADE BEING THE LOWEST AT THE CENTER OF THE COURTYARD. THE SITE MAY BE FLOOD PRONE, ESPECIALLY IF DRAINAGE GRATES CLOG.

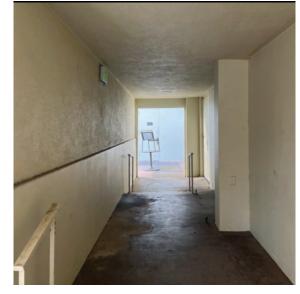

VESTIBULE

THE THEATER REQUIRES A VESTIBULE FOR LIGHT SCREENING DURING PERFORMANCES. THE VESTIBULE OCCUPIES SIGNIFICANT SPACE, CREATES CIRCULATION CONSTRAINTS, AND DISRUPTS THE SYMMETRY OF THE COURTYARD.

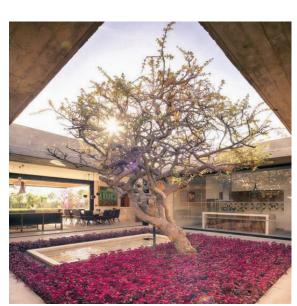

SUN

REMOVING OR ALTERING THE ROOF
WOULD ALLOW MORE SUNLIGHT TO
REACH THE COURTYARD. A LATTICE
STRUCTURE WOULD ALLOW FOR
SOME SHADE DURING HOT SUMMER
MONTHS WHILE ALLOWING FOR MORE
PLANTING OPTIONS. A DECIDUOUS
TREE(S) COULD ALSO PROVIDE
DAPPLED SHADE DURING SUMMER
MONTHS WHILE ALLOWING MORE
SUNLIGHT DURING WINTER.



WIND

A PHYSICAL BARRIER PROVIDES HEDING AND ELIMINATES EDDIES WITHIN THE COURTYARD.



NOIS

THE TALL WALLS PROVIDE
OPPORTUNITY FOR INSTALLATION OF
SOFT MATERIALS, ARTISTIC ACOUSTIC
PANNELS, AND/OR A VERTICAL
GARDEN.



DESIGN IN THE EDGES & EXPAND

THE DOORS AND ADJACENT USES CREATE UNIQUE OPPORTUNITY TO CREATIVELY UTILIZES THE EDGES OF THE COURTYARD. THEY CAN BECOME POINTS OF INTEREST WITH UNIQUE SEATING, ART, OR PLANTINGS THAT OCCUPY THE 'DEAD-SPACE' BETWEEN DOORS. THE SITE CAN EXPAND VERTICALLY TO HAVE A SECOND FLOOR, OR SLIGHTLY OUTWARDS TO THE SOUTH.




WATER CAPTURE


THE INVERTED DRAINAGE CREATES
TREMENDOUS POTENTIAL FOR WATER
HARVESTING, INCLUDING THE DESIGN
OF A RAIN GARDEN OR THE
INSTALLATION OF A CISTERN FOR
WATER CAPTURE AND REUSE.



VESTIBULE

THE VESTIBULE CAN BE REDESIGNED AS A POINT OF INTEREST AND EXPRESSION OF THE ARTS, THROUGH CREATIVE MURALS, ARTWORK, OR A LIVING-VESTIBULE WITH PLANT MATERIALS.

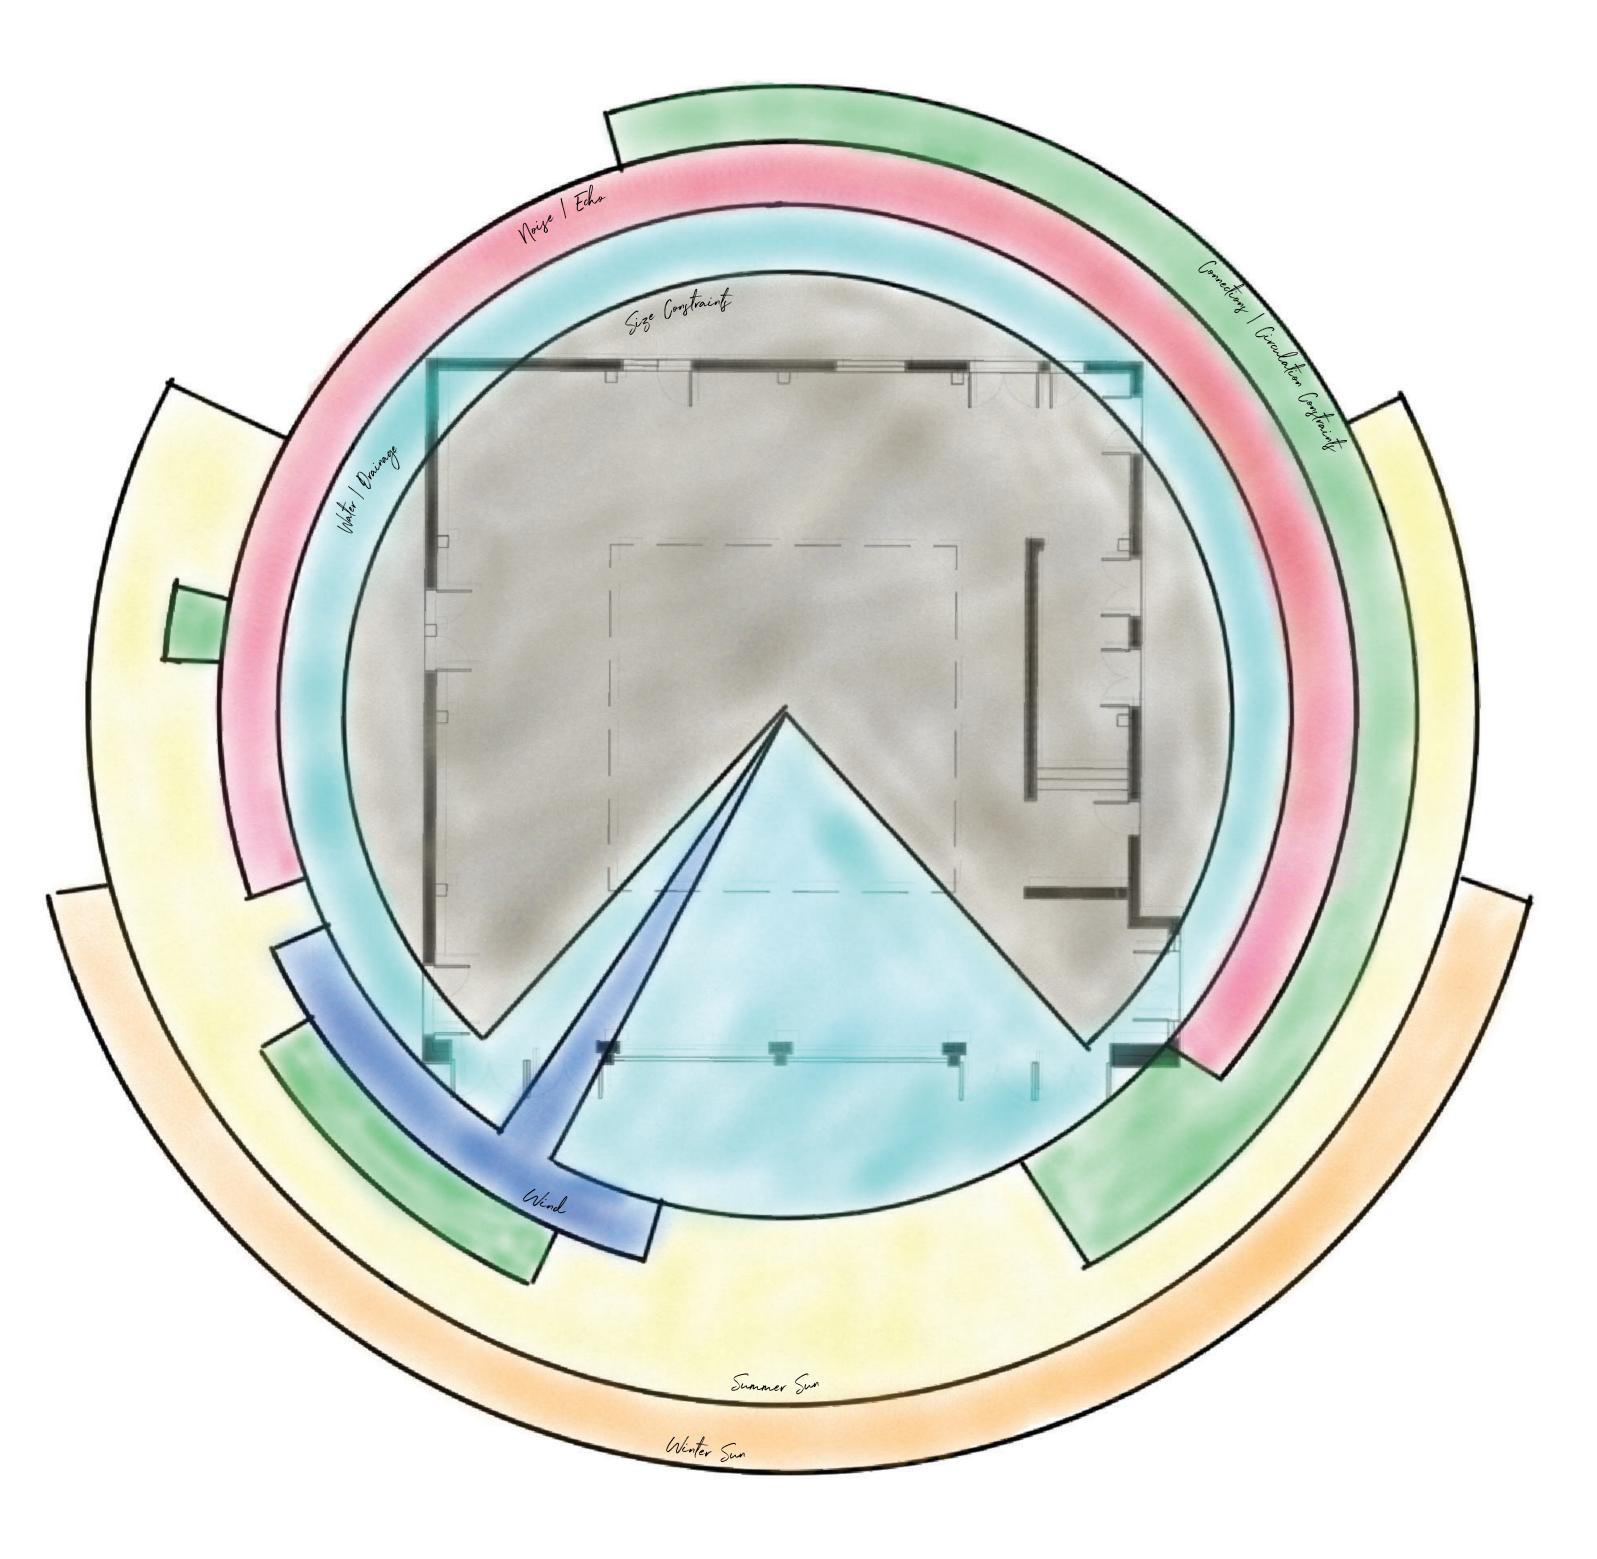

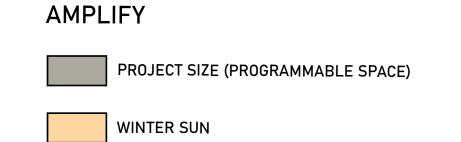

EMBRACE

DRAINAGE / WATER FLOW

CONNECTIONS (ADJACENT USES)

DEFLECT

NOISE

PREVAILING WIND

PREVAILING WIND

DRAWING SCALE:

1/8" = 1'0"

NORTH ARROW:

NUMBER:

_.02 2 OF 6

HEET NUMBER IN SET:

COURSE:

LANDSCAPE DESIGN 1

INSTRUCTOR:

STEVEN CHAVEZ


SITE NAME AND ADDRESS:


STUDENT NAME:

CAL MINGIONE

MACGOWAN HALL COURTYARD 245 CHARLES E YOUNG DR. LOS ANGELES, CA 90095

SITE ANALYSIS

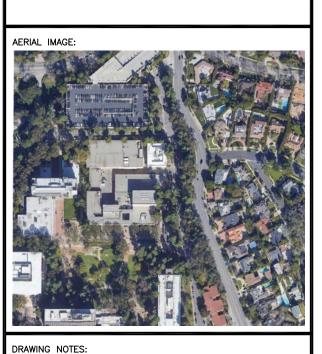

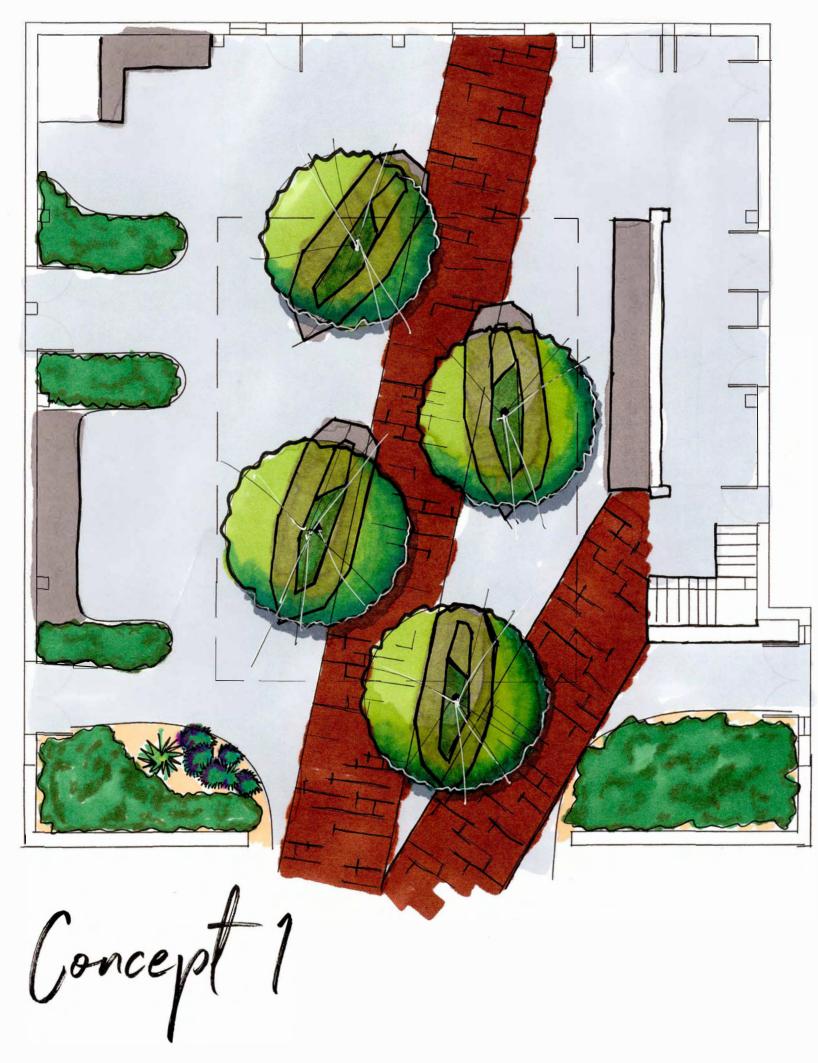

INTENT

THE DESIGN PRIORITIZES PEDESTRIAN CIRCULATION AND SEATING OPPORTUNTIES.

DESIGN COMPONENTS:

- BRISE SOLEIL AT SOUTH ELEVATION IS EXTENDED OUTWARD +/- 8 FEET.
- COURTYARD ENTRY IS SHIFTED TO BE CENTRAL.
- ROOF IS PULLED BACK TO ALLOW FOR ADDITIONAL SUN EXPOSURE.
- SECOND FLOOR PROVIDED ATOP VESTIBULE AND ALONG NORTHERN EDGE.
- PAVERS PROVIDE STRONG EMPHASIS TO PRIMARY CIRCULATION PATTERNS. - ISLANDS PROVIDING SEATING, WITH RAISED PLANTERS IN THE MIDDLE. PLANTERTS ACCOMODATE
- TALL DESCIDUOUS TREES.

FIRST FLOOR:






DELIGHTFULLY PASSIVE

THE DESIGN CREATES A PROGRAMMABLE LAWN SPACE THAT ENTICES RELAXATION AND SOCIALIZATION

DESIGN COMPONENTS:

- BRISE SOLEIL AT SOUTH ELEVATION IS EXTENDED OUTWARD +/- 8 FEET.
- COURTYARD ENTRY IS SHIFTED TO BE CENTRAL.
- ROOF IS PULLED BACK TO ALLOW FOR ADDITIONAL SUN EXPOSURE.
- CENTRAL, ORGANIC "C' SHAPED SEATING TAKES ON A NATURAL WANDERING FORM.
- RAISED PLANTER AREA WITH SHRUBS AND TREES BIFURCATED SEAT BENCH.
- SUNKEN LAWN AREA NESTLES INTO SEATING.
- MODULAR/MOVABLE FURNITURE PROVIDED TO ALLOW FOR FLEXIBLE GATHERING ARRANGEMENTS.
- VESTIBULE WALL TRANSFORMED INTO WATER FEATURE (WATER WALL).
- PLANTER AREAS GUIDE PEDESTRIAN CIRCULATION, AND ALLOW FOR WATER DRAINAGE.

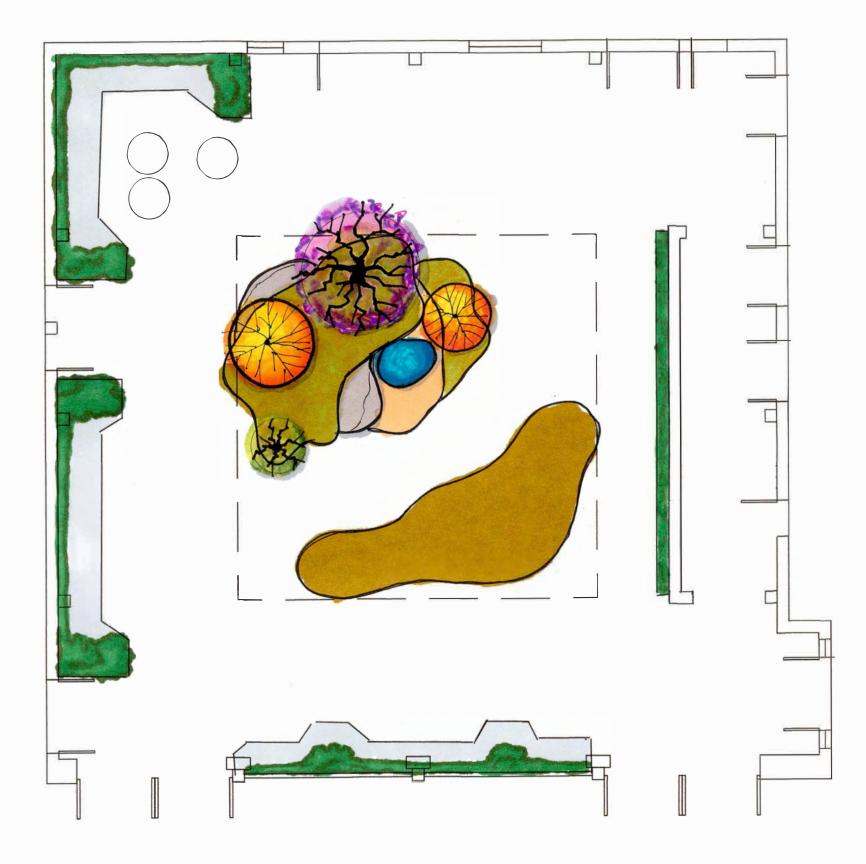

ZEN

THE DESIGN CREATES A NATURAL AND CONTEMPLATIVE SPACE.

DESIGN COMPONENTS:

- ROOF DIMENSIONS PRESERVED, BUT SOLID MATERIAL REPLACED TO MATCH BRISE SOLEIL.
- ZEN GARDEN (CHARACTERISTIC OF JAPANESE GARDEN) PROVIDED:
- + BUILT UP INTO MOUNDS + PLANTED WITH SHRUBS AND TREES
- + INCLUDES SMALL WATER ELEMENTS
- + BOULDERS AND NATURAL ELEMENTS PROVIDE SELECT SEATING
- A SUNKEN RAIN GARDEN IS MADE OUT OF THE DEPRESSION USED TO CREATE THE MOUNDED ZEN GARDEN
- + INCLUDES WATER TOLERANT PLANTS
- + FACILITATES SITE DRAINAGE.
- VESTIBULE WALL REDESIGNED SO ENTRY/EXITS ARE ORIENTED NORTH/SOUTH; WESTERN WALL UTILIZED AS GREEN WALL.
- SEATING PROVIDED ALONG THE PERIMETER OF THE COURTYARD, WITH MININIMALIST DESIGN TO PRESERVE THE GARDEN ELEMENTS AS THE FOCUS.


LANDSCAPE DESIGN 1 STEVEN CHAVEZ SITE NAME AND ADDRESS: MACGOWAN HALL COURTYARD 245 CHARLES E YOUNG DR.

LOS ANGELES, CA

90095

CAL MINGIONE

DESIGN ALTERNATIVES

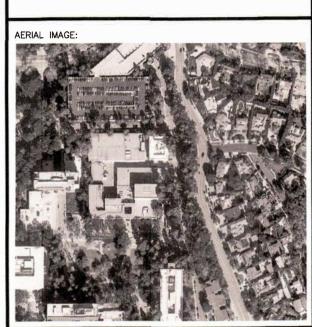


NORTH ARROW:



1/8" = 1'0"

SHEET NUMBER IN SET: 3 OF 6

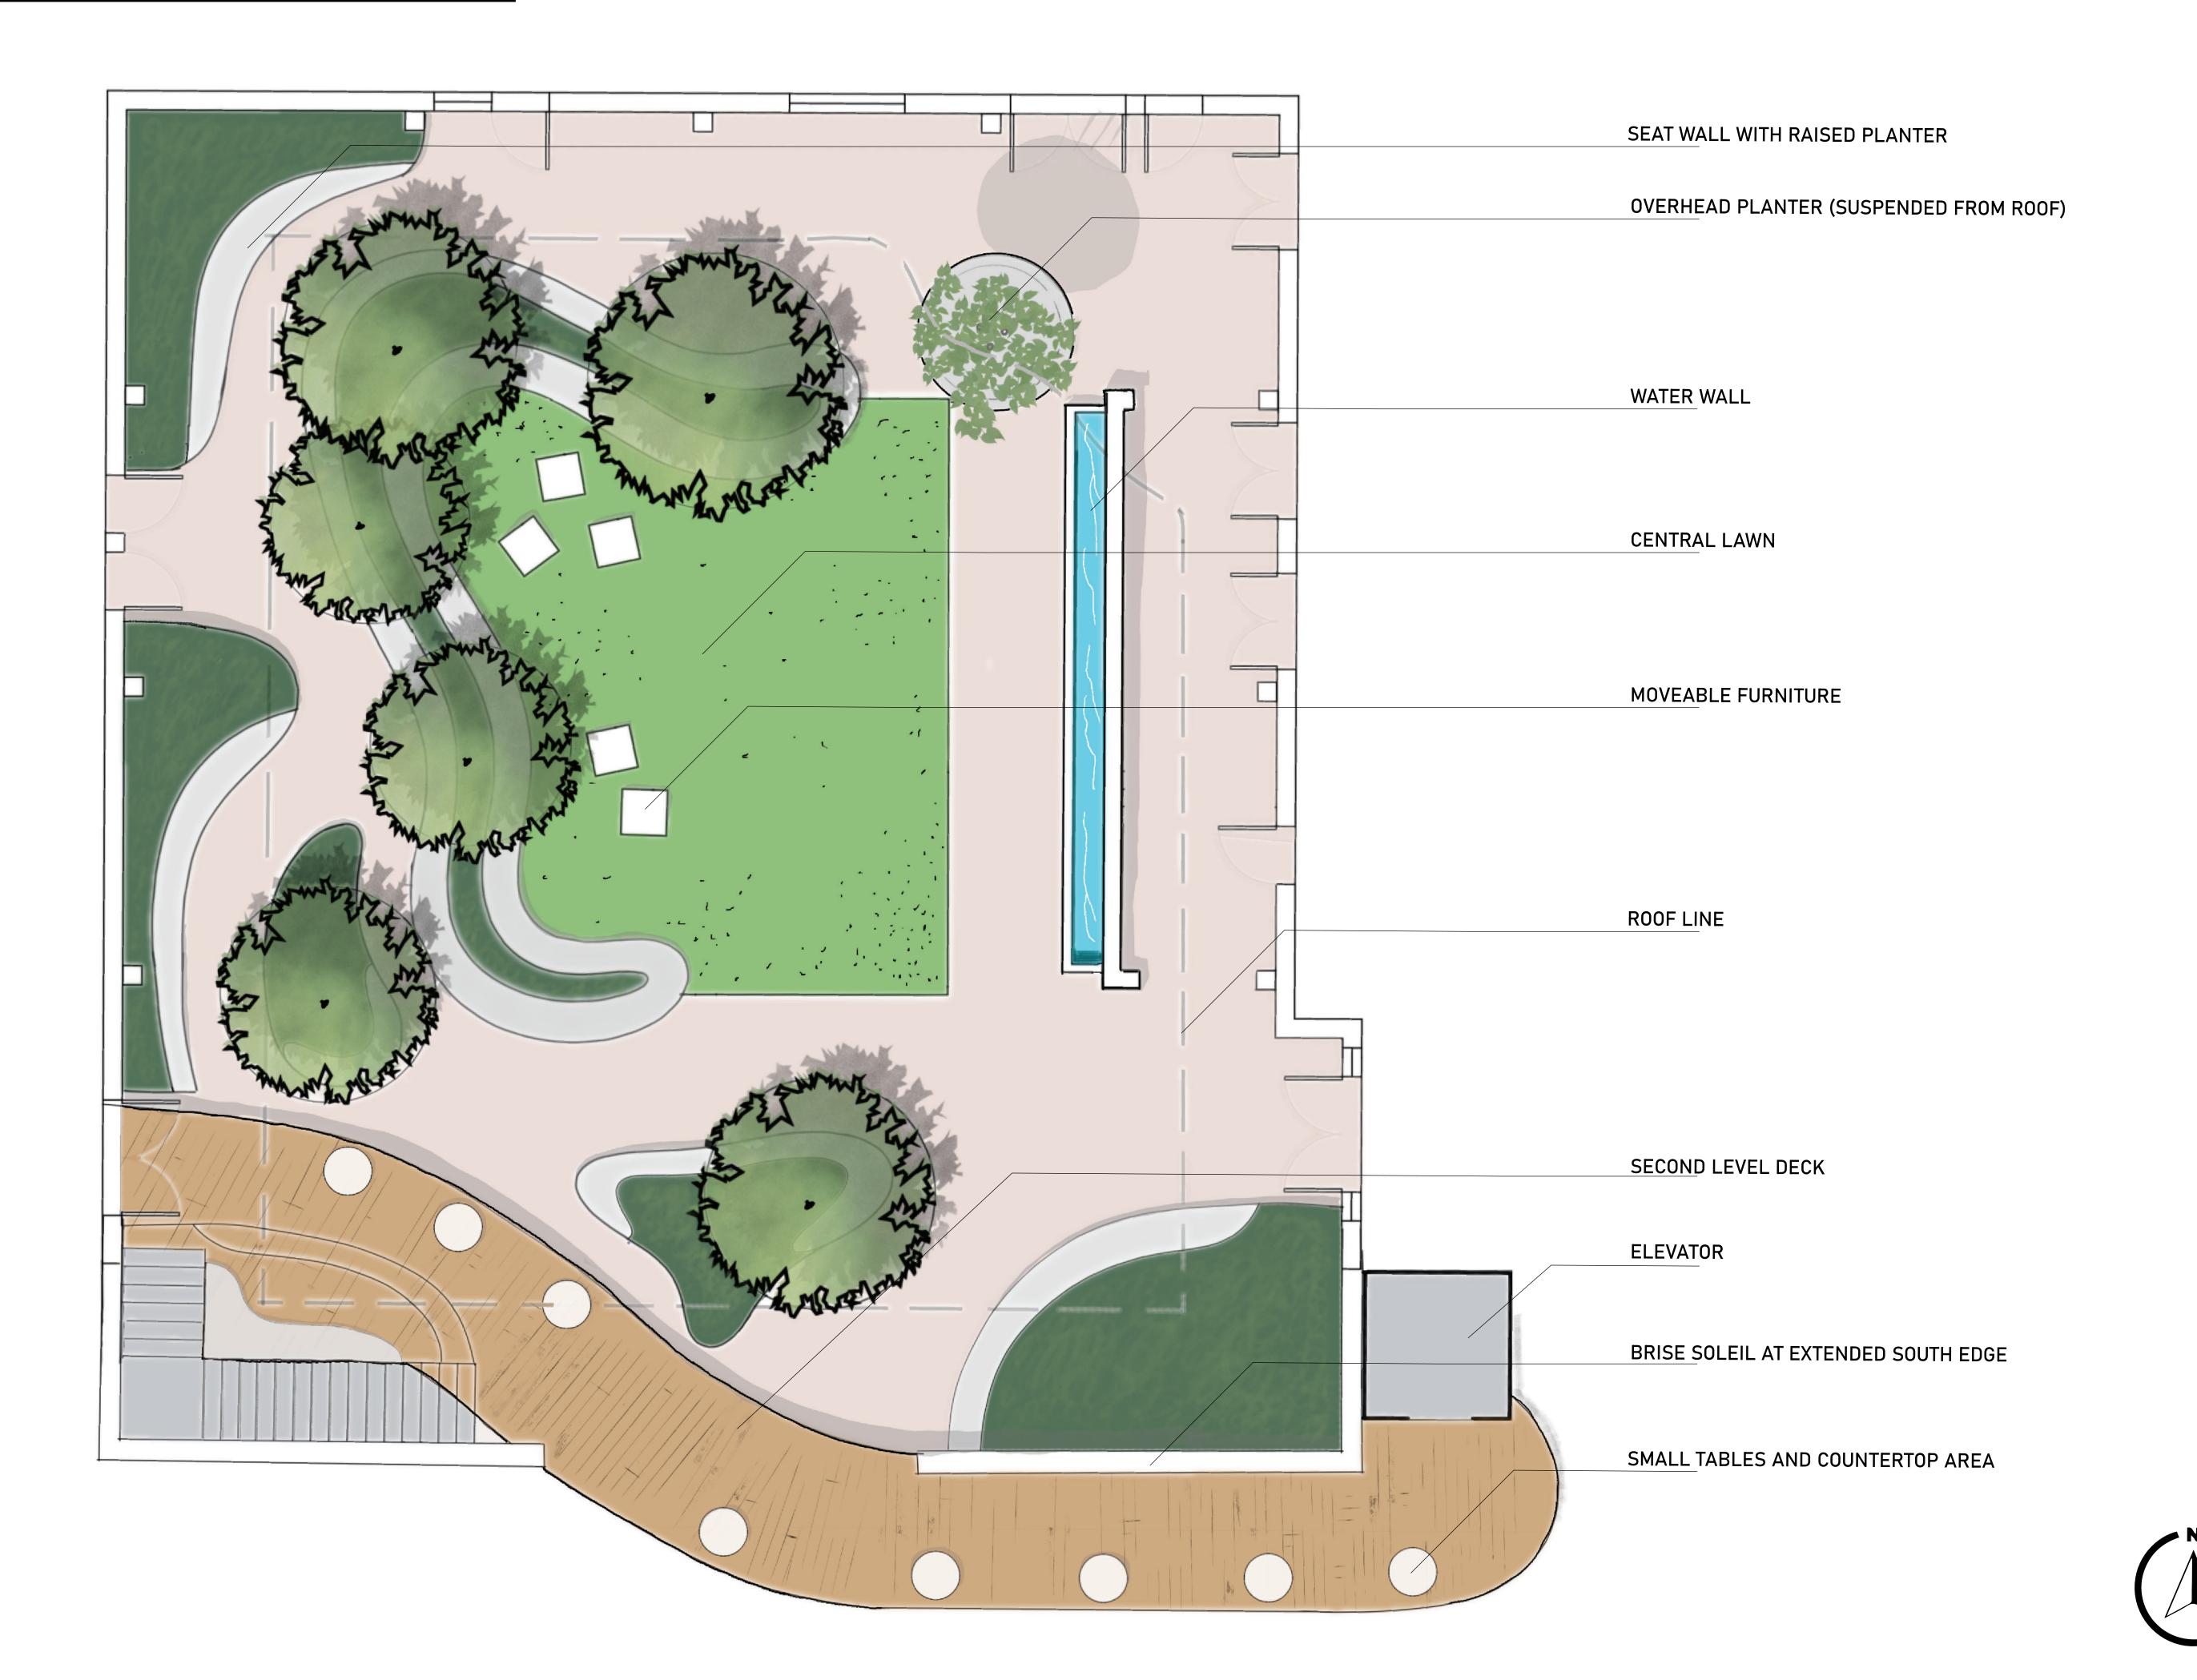

STUDENT NAME: **CAL MINGIONE**

LANDSCAPE DESIGN 1

STEVEN CHAVEZ

SITE NAME AND ADDRESS:

MACGOWAN HALL COURTYARD 245 CHARLES E YOUNG DR. LOS ANGELES, CA 90095

SITE DESIGN



THE DESIGN INCORPORATES CURVILINEAR FORMS AND NATURAL ELEMENTS TO SOFTEN THE STRONG EDGES AND HARSH VERTICALLITY OF THE EXISTING COURTYARD WHILE
CREATINGS AN ENVIRONMENT CAPABLE OF
ACCOMODATEING PERSONAL STUDY, RELAXATION, INTIMATE GATHERINGS, AND/OR SOCIAL

THE WATER WALL SERVES AS THE FOCAL POINT OF THE DESIGN, WHILE PRESERVING THE BENEFITS OF THE EXISTING VESTIBULE TO THE THEATER.

A CENTRAL, PROGRAMMABLE LAWN IS ORIEN-TED TOWARDS THE WATER WALL, AND CAN BE UTILIZED FOR SOCIAL GATHERINGS, MEDITATION, YOGA, SUNBATHING, OR OTHER PASSIVE RECREATION OPPORTUNITIES.

THE LAWN IS BOUNDED BY A LARGE, MEAND-ERING, 'C"-SHAPED PLANTER, WHICH FEATURES LOW SHRUBS/GRASSES, A COMB-INATION OF DECIDUOUS AND EVERGREEN TREES, AND BENCH SEATING ON BOTH SIDES.

THE UTILITY OF THE EDGES IS MAXIMIZED BY PROVIDING SEAT WALLS CUT INTO RAISED PLANTER BEDS, WHICH PROVIDE ADDITIONAL GREENERY AND REDUCE BOTH NOISE ECHO AND WIND EDDYING.

THE BRISE SOLEIL IS PRESERVED, BUT ALTERED TO ALLOW FOR THE SOUTHERN EXPANSION OF COURTYARD. THE ENTRANCE IS REPOSITIONED FROM THE SIDES TO THE


THE ROOF LINE IS DRAWN BACK TO ALLOW FOR MORE LIGHT AND SUN INTO THE SPACE.

A LARGE CIRCULAR PLANTER IS SUSPENDED FROM THE ROOF IN THE NORTHEAST CORNER, WHICH PROVIDES VISUAL INTEREST THAT COMPLEMENTS THE WATER WALL AND CONTI-NUES THE MEANDERING PLACEMENT OF TREES AND GREEN ELEMENTS DANCING THROUGH THE SITE WHILE PRESERVING GROUND-PLANE ACCESS TO THE TICKET WINDOW AND THEATER EXIT DOORS.


A CURVILINEAR DECK IS ADDED TO THE SECOND LEVEL, ACCESSABLE VIA STAIRS AND AN ELEVATOR., AND IT INCLUDES SMALL TABLES AND COUTERTOP AREAS WITH VIEWPOINTS OF THE WATER ELEMENT (INTERIOR OF THE SITE) AND THE ADJACENT SCULPTURE GARDEN (EXTERIOR OF THE SITE).

1/4" = 1'0"

HEET NUMBER IN SET:

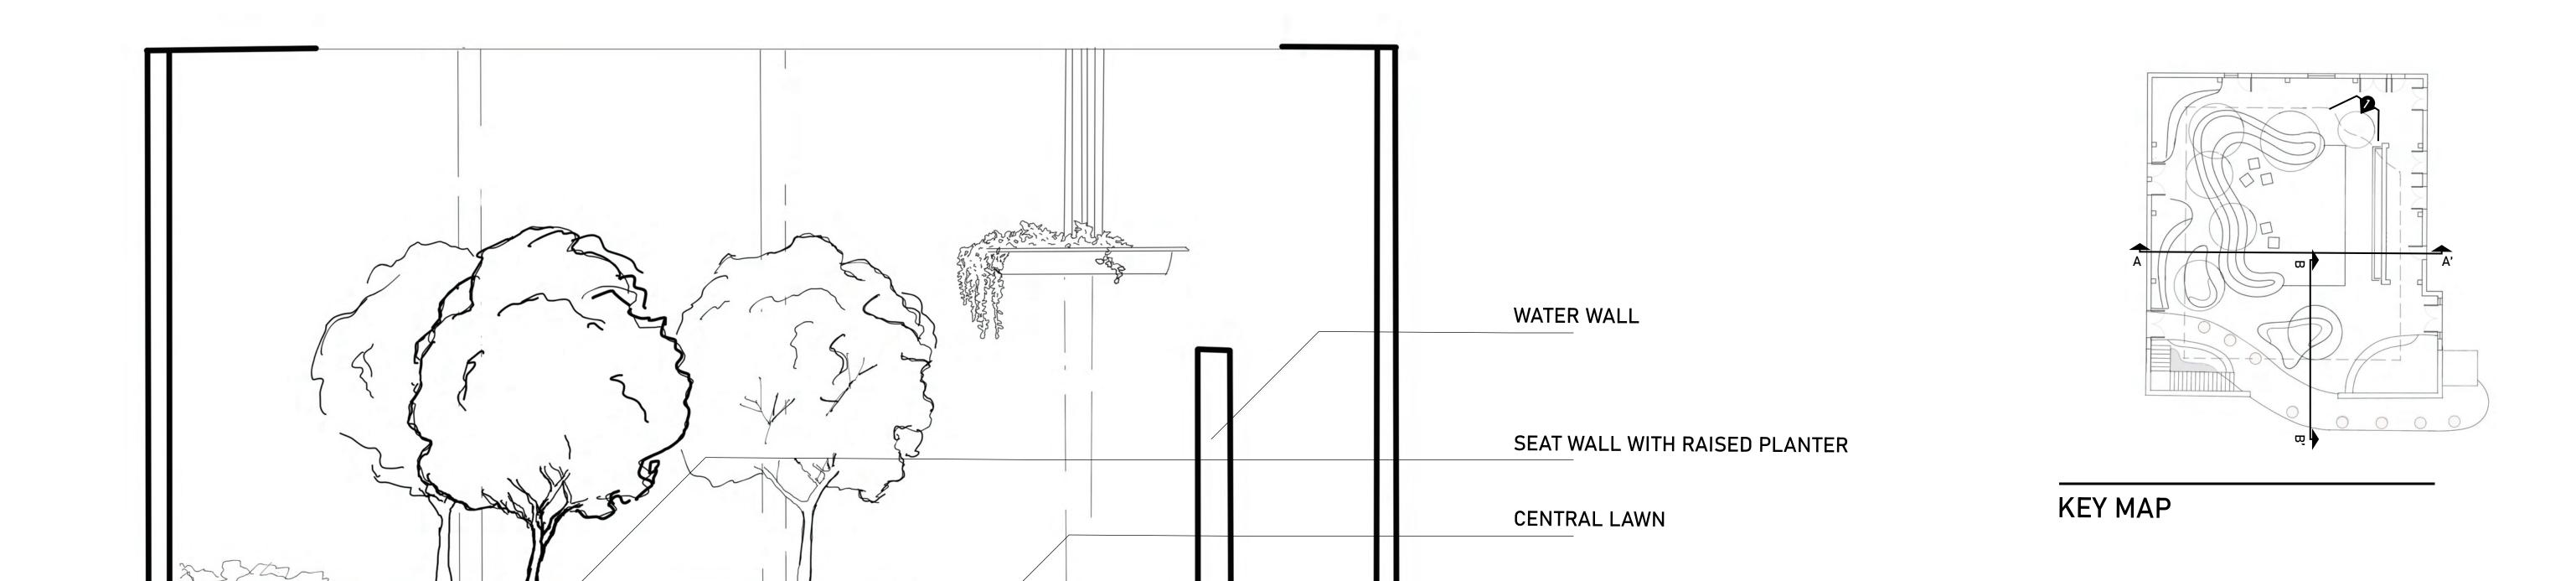

SECTION ELEVATION A-A'

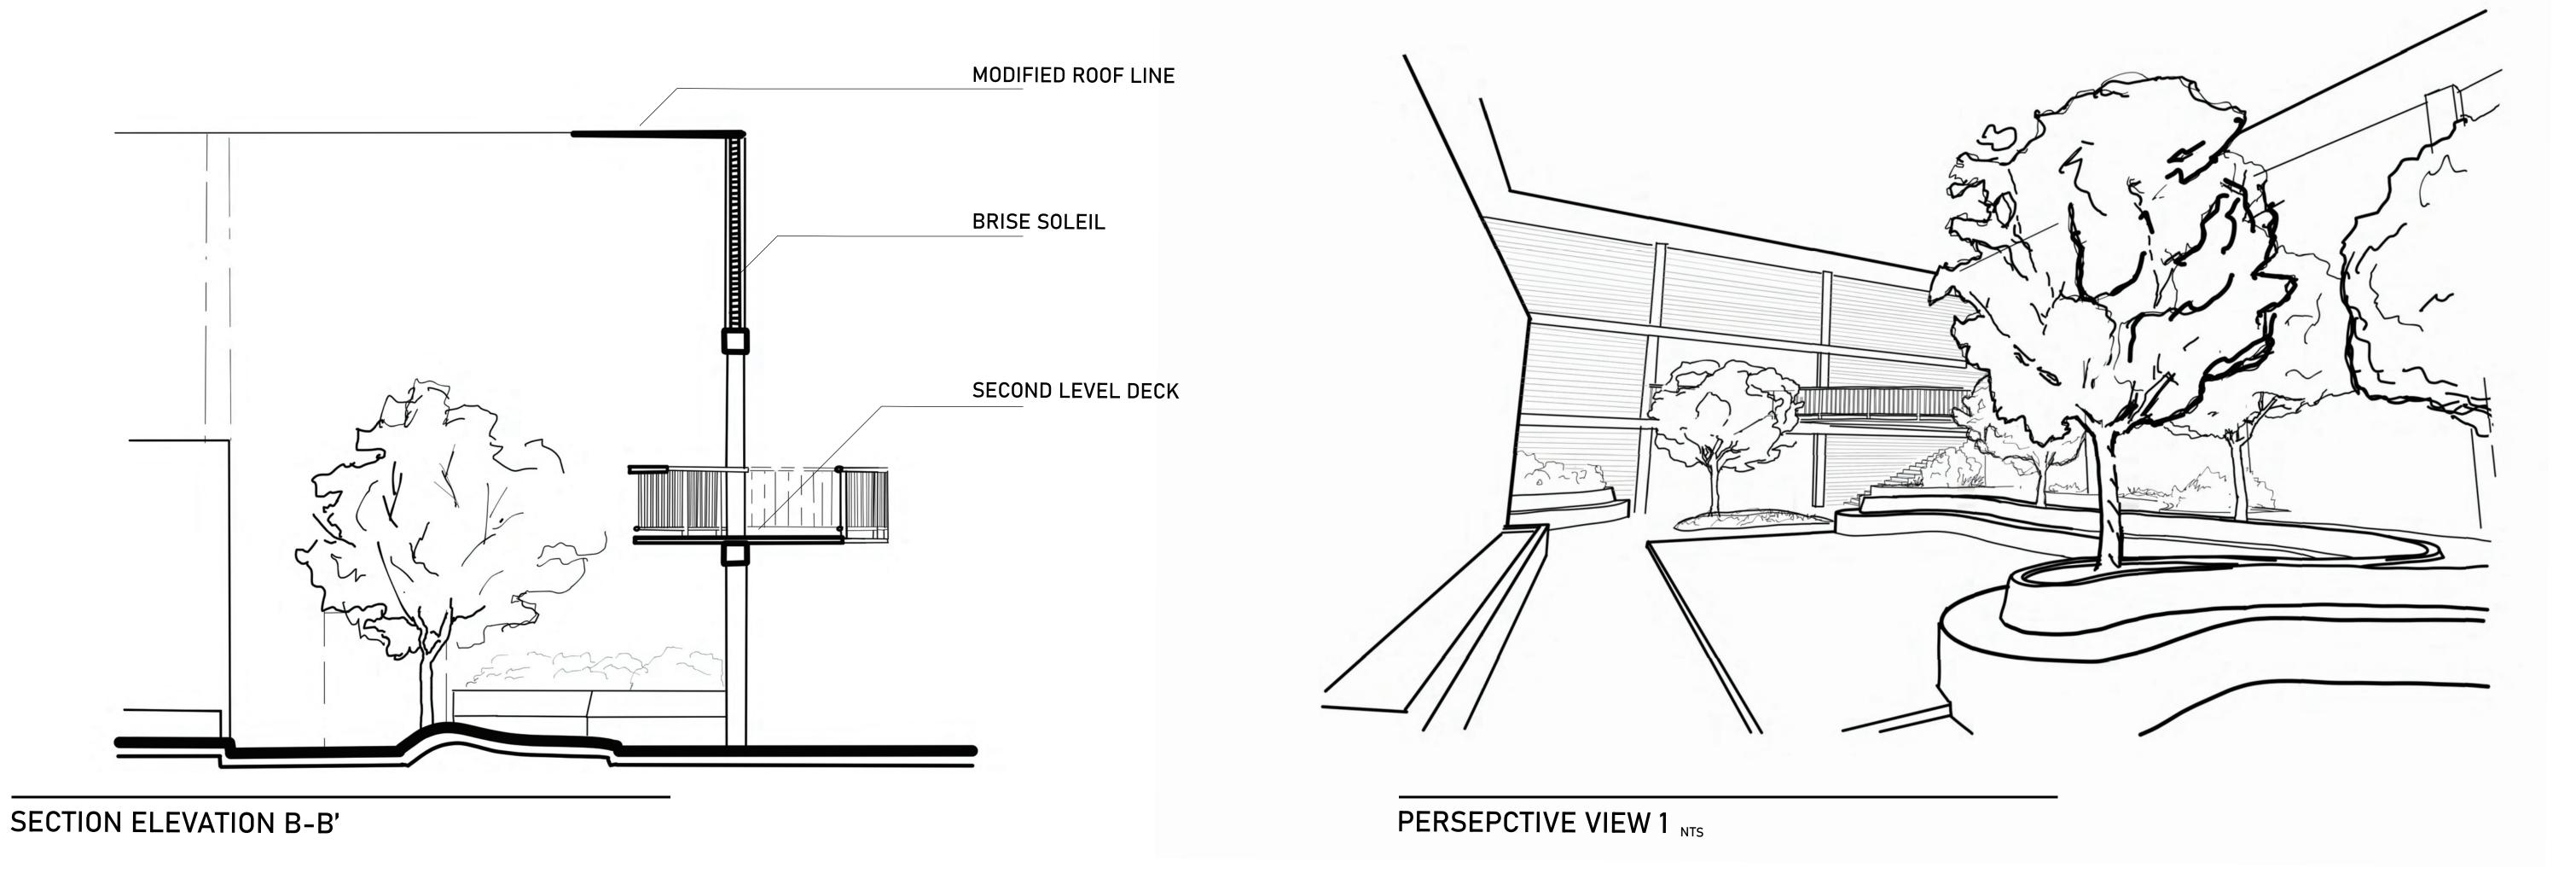

STUDENT NAME:

CAL MINGIONE

COURSE:

LANDSCAPE DESIGN 1


INSTRUCTOR:
STEVEN CHAVEZ

SITE NAME AND ADDRESS:

MACGOWAN HALL COURTYARD 245 CHARLES E YOUNG DR. LOS ANGELES, CA 90095


PRAWING TITLE:

SECTIONS & PERSPECTIVE

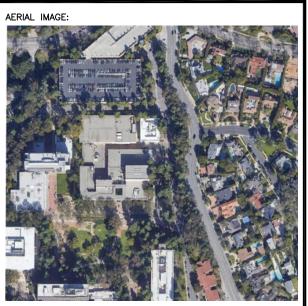

DRAWING NOTES

NORTH ARROW:

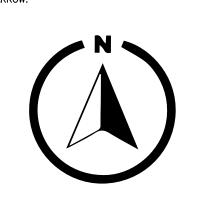

0 2'6" 5'0" 10'0"

DRAWING SCALE:

1/4" = 1'0"

L.05 | 5 OF 6















COURSE:

LANDSCAPE DESIGN 1

INSTRUCTOR:
STEVEN CHAVEZ

SITE NAME AND ADDRESS:

MACGOWAN HALL COURTYARD 245 CHARLES E YOUNG DR. LOS ANGELES, CA 90095

DRAWING TITLE:
MODEL RENDERINGS



DRAWING NOTES





NORTH ARROW:

CALE BAR:

AWING SCALE:

NUMBER: SHEET NUMBER IN

L.06 6 OF