LANDSCAPE DESIGN1

ARCH-X 471.1A



DESIGNER - BRENNAN GROH
INSTRUCTOR - STEVEN CHAVEZ









RENOVATION





STEVEN CHAVEZ

INSTRUCTOR

STUDENT NAME

BRENNAN GROH


LANDSCAPE DESIGN 1

SITE NAME AND ADDRESS MACGOWAN HALL COURTYARD

245 CHARLES E YOUNG DR E, LOS ANGELES, CA 90095

DRAWING TITLE

ASSIGNMENT 2 SITE INVENTORY AND ANALYSIS

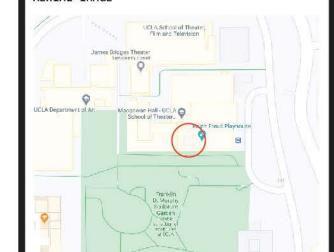

DRAWING NOTES
BUILT IN 1962, LOCATED BETWEEN THE LITTLE
THEATRE AND THE FREUD PLAYHOUSE

RENOVATED IN 1993, REMOVING THE ORIGINAL BENCHES, SCULPTURE, AND FLOOR WHILE ADDING SUPERFICIAL FACADES TO THE TICKET WINDOW

THEATER AND MOTION-PICTURE PRODUCER
AND FIRST CHAIRMAN OF THE UCLA THEATER

ENTRANCE IS LOCATED OFF OF THE MURPHY SCULPTURE GARDEN THROUGH THE CORAL

TREE WALK

EXISTING TREES SEEM TO BE STRUGGLING TO REACH THE LIGHT COMING FROM THE OPENING IN THE CEILING

EXISTING SEATING IS LIMITED TO A CENTRAL SQUARE BENCH, SUPPLEMENTED BY OFF-THE-SHELF CAFE TABLE/CHAIR SETS

CRACKS IN FLOOR SHOW POTENTIAL SIGNS OF


COURTYARD ACCOUSTICS CAUSE AN ECHO EFFECT INSIDE OF THE COURTYARD


SHADOWS CAST FROM METAL SCRIM OFFER VISUAL INTEREST THROUGHOUT THE DAY

COURTYARD DIMENSIONS ARE 60' X 60' X 30'

ENTRANCE/EXIT DOORS ON EVERY WALL

NORTH ARROW

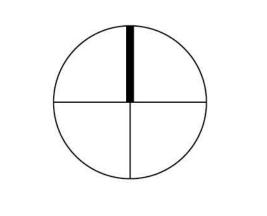

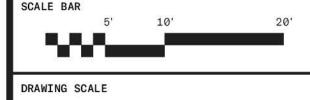

1/8'' = 1'-0''


SHEET NUMBER SHEET NUMBER IN SET 2/9







MURPHY SCULPTURE GARDEN

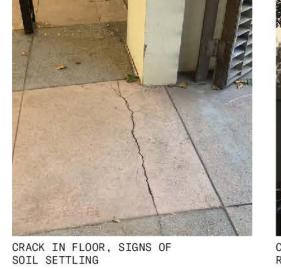











MARQUEE POSTER AND DOWNSPOUT AT EAST ENTRANCE



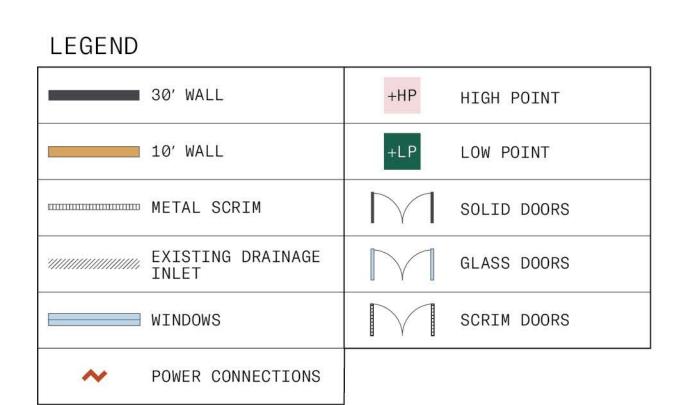


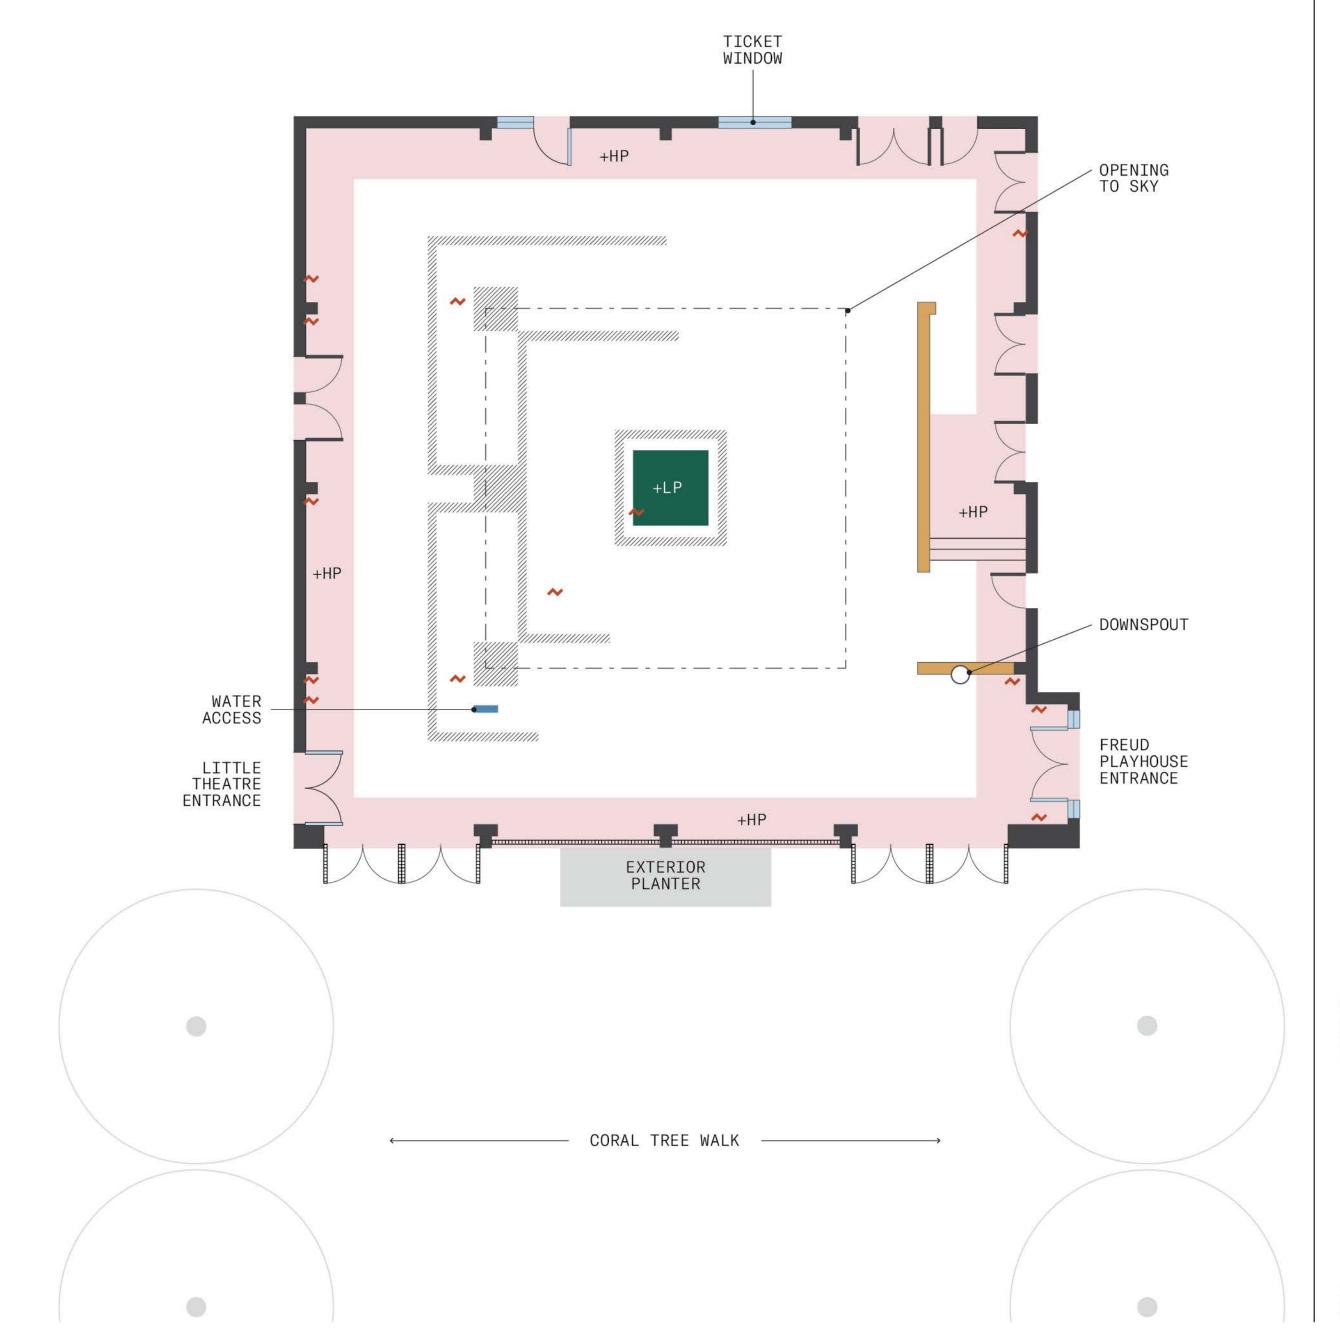


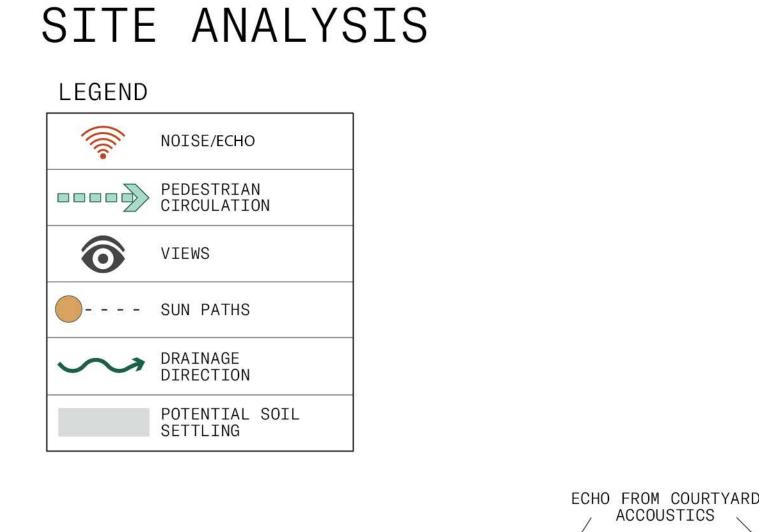

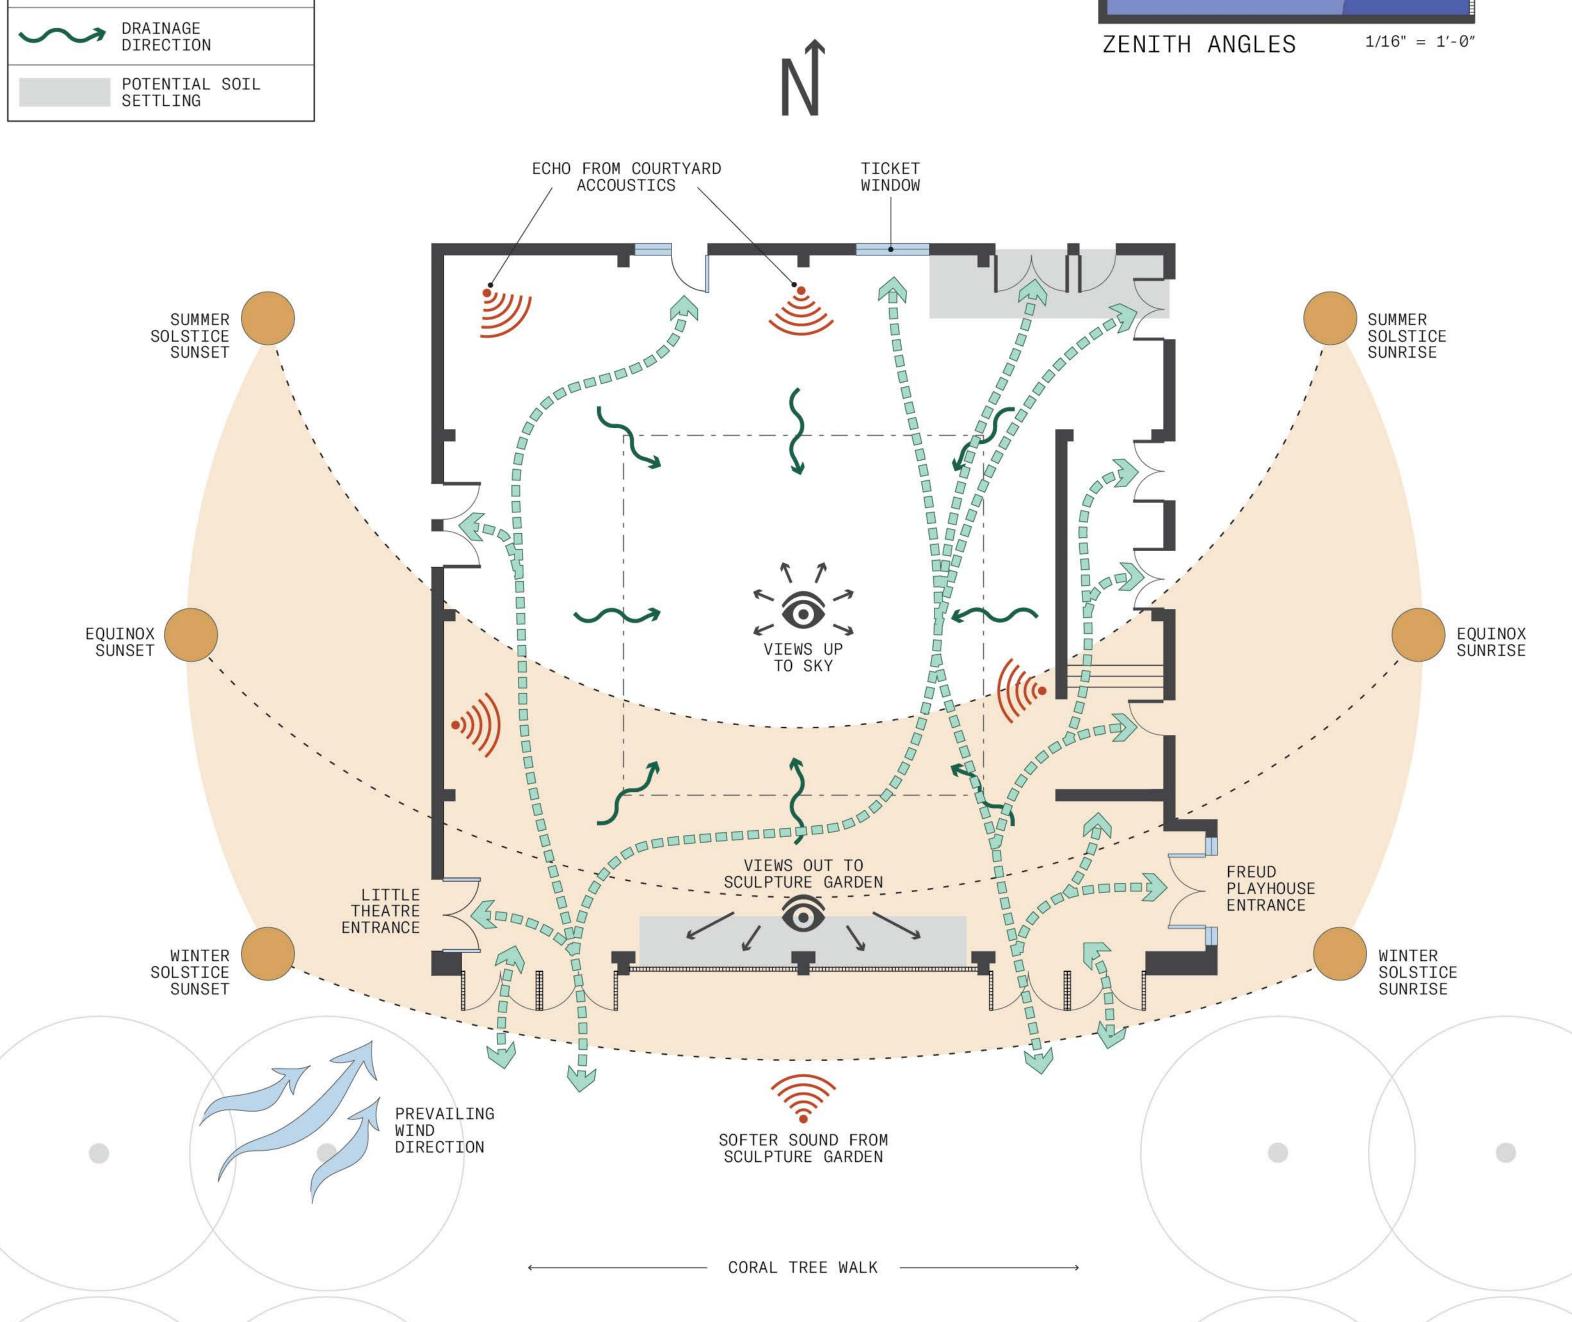


MURPHY SCULPTURE GARDEN

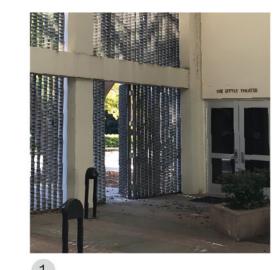

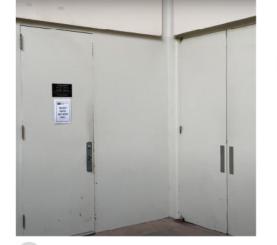





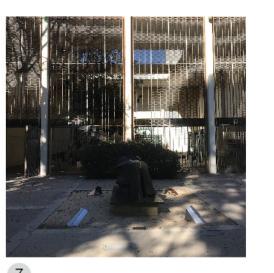

SITE CONSTRAINTS

SITE SHAPE+ VOLUME THE SITE IS SURROUNDED BY 30' WALLS ON 3 SIDES

PEDESTRIAN CIRCULATION

- 1 THE COURTYARD ENTRANCES ARE TOO CLOSE TO THE THE-ATRE DOORS WHICH CAN BECOME CROWDED DURING PEEK
- 2 THE COURTYARD IS SURROUNDED BY MANY DOORS THAT FURTHER COMPLICATE PEDESTRIAN CIRCULATION PATTERNS AND IMPEDE ON THE SPACE USAGE
- 3 TICKET WINDOW IS PLACED ACROSS THE COURT YARD FROM THE ENTRANCE AND CREATES A CONVOLUTED PEDESTRIAN CIRCULATION PATH

TICKET WINDOW IS OBSOLETE WITH MODERN TECHNOLOGY

LIGHT

4 WALLS + SEMI-COVERED ROOF LIMIT DIRECT SUNLIGHT

WATER

SEMI-COVERED ROOF AND ROOF SHAPE LIMIT STORM WATER RUNOFF

5 INVERTED DRAINAGE DIRECTS WATER TO THE CENTER OF THE SITE

AIR ENCLOSED SPACE LIMITS AIR CIRCULATION

6 WIND EDDYING CAN CREATE AN UNPLEASANT **ENVIRONMENT**

SOUND

MATERIALS AND VOLUME OF SPACE CREATES AN ECHO EFFECT WITH SOUND FROM WITHIN THE SPACE

SIGHT

CAPACITY

COURTYARD CAPACITY - 100 PEOPLE

NOTE - BE MINDFUL OF PEDESTRIAN


FREUD PLAYHOUSE - 562 SEATS


CIRCULATION WHEN BEFORE AND

AFTER PERFORMANCES

LITTLE THEATRE - 178 SEATS

7 SCRIM FACADE ALLOWS VIEWS OUT TO THE SCULPTURE GARDEN BUT CREATES A VISUAL BARRIER AND IS NOT INVITING

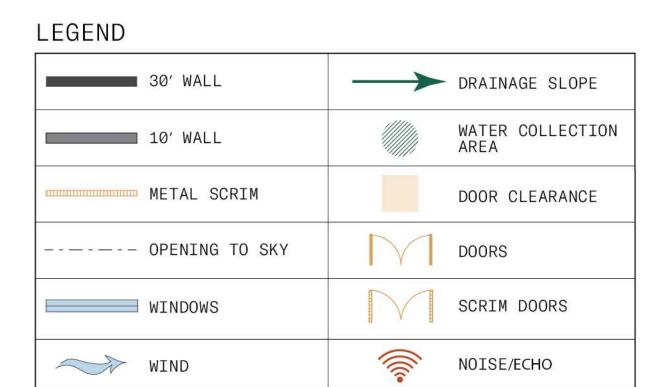

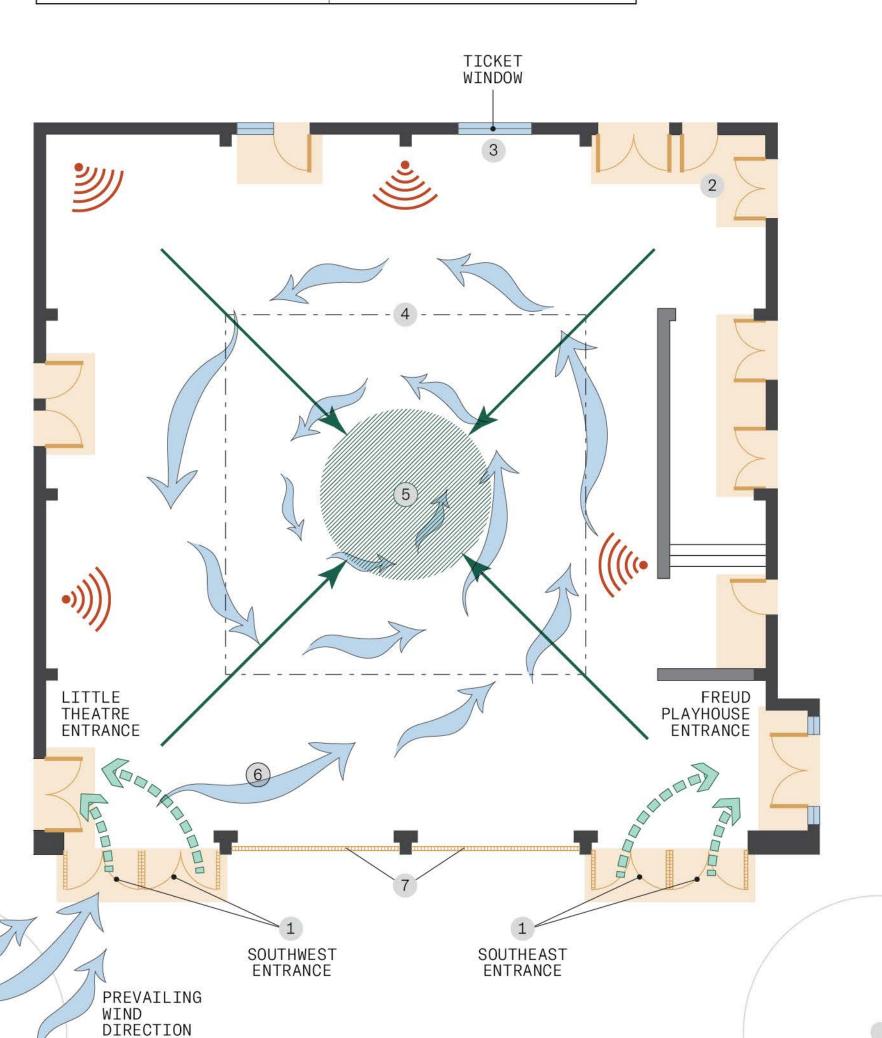

CORAL TREE WALK ----

MURPHY

SCULPTURE GARDEN

SITE OPPORTUNITIES



ADDITION OF LARGE SCALE ART

ACTIVATING THE CENTER OF THE

SPACE HELPS TO OPEN PEDESTRIAN

TO THE SURROUNDINGS

PATHS AROUND THE SPACE


INTEGRATE GROUND FLOOR

AREAS

SEATING IN LOWER TRAFFIC

PROVIDES A FOCAL POINT FOR THE SPACE AND BETTER CONNECTS IT



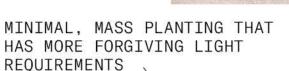



VIEWS UP

TO SKY

VIEWS INWARD AND

OUTWARD

CENTRAL WATER FEATURE BUBBLES UP FROM FLOOR. TAKES ADVANTAGE OF INVERTED DRAINAGE, AND CREATES A SOFT WHITE NOISE



TICKET BOOTH BECOMES A MICRO CAFE TO PROVIDE A SOCIAL COMPONENT TO THE



INTEGRATED POCKET PLANTING INTO UPDATED WALL FACADE ON NORTH END OF COURTYARD

UTILIZE WATER CAPTURED ON ROOF TO HELP WITH IRRIGATION



CENTRAL SPIRAL STAIRCASE CONNECTS TO BALCONY SEATING

REMOVE 10' WALL TO INCREASE SPACE B/C IT IS NO LONGER NECESSARY



FLOOR SURFACE USED TO HELP



DIRECT PEDESTRIAN CIRCULATION (SUBLIMINAL WAY-FINDING)



LOWER, CANTILEVERED EXTENSION OFF THE FRONT OF THE COURTYARD DRAWS ATTENTION TO THE ENTRANCE, INVITES PEOPLE IN, AND CREATES A 'FOYER-LIKE' ENTRANCE TO HELP ALLEVIATE CONGESTION AT THEATRE **ENTRANCES**

IN-GROUND LIGHTING USED TO DRAW ATTENTION TO THE ENTRANCE AND DIRECT PEDESTRIAN CIRCULATION IN THE EVENING





STUDENT NAME

INSTRUCTOR

STEVEN CHAVEZ

SITE NAME AND ADDRESS

DRAWING TITLE

AERIAL IMAGE

ASSIGNMENT 3

SITE CONSTRAINTS +

SITE OPPORTUNITIES

MACGOWAN HALL COURTYARD

245 CHARLES E YOUNG DR E,

LOS ANGELES, CA 90095

BRENNAN GROH

LANDSCAPE DESIGN 1

DRAWING NOTES REACTING TO THE CHALLENGES OF THE SITE CONSTRAINTS, THERE ARE OPPORTUNITIES TO CREATE A BETTER FUNCTIONING SPACE THAT ALSO PROVIDES ADDED VALUE TO THE STUDENTS AND CAMPUS VISITORS.


IN THIS UPDATE, IT IS IMPORTANT TO HONOR AND RESPOND TO THE EXISTING ARCHITECTURE SITE LOCATION AND USAGE WHILE BREATHING NEW LIFE INTO THIS HIDDEN COURTYARD.

ON FIRST VISIT TO THE SITE, IT FELT VERY UNINVITING, AS IF YOU WEREN'T SUPPOSED TO BE THERE. THERE ARE A HANDFUL OF ENTRANCE UPDATES THAT WILL HELP DRAW ATTENTION TO THE COURTYARD, INVITE PEOPLE INTO THE SPACE, AND BETTER GUIDE PEDESTRIAN CIRCULATION TO THE THEATERS AND THROUGH THE GREATER SPACE.

TO HELP FURTHER ACTIVATE THE SPACE, A MICRO-CAFE WILL REPLACE THE UNDER-USED TICKET WINDOW. IN ADDITION, INTEGRATED SEATING WILL BE ADDED IN LOWER TRAFFIC AREAS AS WELL AS A SECOND FLOOR BALCONY THAT WILL OVERLOOK THE SCULPTURE GARDEN AND THE INTERIOR OF THE SPACE.

INCLUDING A CENTRAL ELEMENT IN THE COURTYARD PROVIDES A FOCAL POINT AND ALSO HELPS CREATE A MORE FLEXIBLE SPACE.

UTILIZING THE HEIGHT OF THE WALLS, SYMPATHETIC MATERIALS USED IN UNCONVENTIONAL WAYS AND PLANTING POCKETS WILL HELP ABSORB SOUND, ADD VISUAL INTEREST AND LIFE TO THE SPACE.

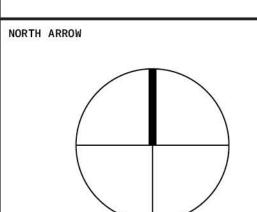



DRAWING SCALE


L3

SHEET NUMBER

1/8'' = 1'-0''

SHEET NUMBER IN SET 3/9



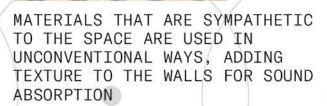

ADDITIONAL DOORS ADDED TO THE CENTER OF THE FACADE TO HELP DIRECT THE FLOW OF TRAFFIC BEFORE AND AFTER PERFORMANCES

REMOVE DOORS IF POSSIBLE

UPDATÉ SCRIM FOR INCREASED PROTECTION FROM WIND



SECOND FLOOR ADDITION CONTINUES THE LINE FROM THE EXTERIOR CANTILEVER ENTRANCE FROM OUTSIDE TO INSIDE AND INCORPORATES INTEGRATED SEATING + PLANTING POCKETS PROVIDING A VIEW OF THE SCULPTURE GARDEN AND COURTYARD

LOWER 'CEILING' ON GROUND FLOOR ENCOURAGES PEOPLE TO PASS THROUGH THE SPACE

CONCEPT 1 - VIEW

THE CENTRAL FOCAL POINT IS A GROUND LEVEL SURFACE WATER FEATURE THAT SURROUNDS A SCULPTURE, REFERENCING THE ORIGINAL USE FOR THE SPACE. THE WATER FEATURE MAY BE TURNED OFF TO REPROGRAM THE SPACE FOR OTHER ACTIVATIONS. A SECOND FLOOR FLANKS EITHER SIDE OF THE COURTYARD IN RESPONSE TO THE NUMEROUS DOORS THAT SURROUND THE COURTYARD. ONE SIDE FEATURES A TERRACED VIEWING DECK AND PLANTING AREA WHILE THE OTHER SERVES AS A GREEN ROOF ABOVE THE EXTENDED FOYER. A CANTILEVERED PLAIN HIGHLIGHTS THE ENTRANCE, WELCOMES GUESTS, AND ENCOURAGES THEM TO MOVE THROUGH THE SPACE.


CONCEPT 2 - CONTEMPLATION

THIS CONCEPT BUILDS OFF OF THE SACRED CIRCLE AND SYMMETRY. THE CENTRAL FOCAL POINT IS A SPIRAL STAIR CASE WITH AN OFFSET PLANTING BED ON THE GROUND FLOOR. THE STAIRCASE LEADS TO A SECOND FLOOR STUDY AREA, ABOVE THE EXTENDED FOYER, IN THE CANOPY OF THE CORAL TREES, AN ESCAPE FROM THE CAMPUS. THE WALLS ARE CLAD WITH A DIMENSIONAL MATERIAL THAT ALSO INCLUDES PLANT POCKETS FOR ADDITIONAL INTEREST AND TO HELP DAMPEN SOUND TO PROMOTE CONTEMPLATION AND STUDY.

CONCEPT 3 - RESPONSE

THIS CONCEPT RESPONDS TO THE BUILDING ITSELF, TAKING CUES FROM THE INTERNAL STRUCTURE AND GRID SYSTEM SET UP BY THE COURTYARD. VISUAL INTEREST IS BROUGHT IN THROUGH CHANGES IN GROUND MATERIAL, GROUND LEVEL AND RAISED PLANTING AREAS, AND SYMPATHETIC SEATING SPACES. THE GROUND LEVEL PLANTING AREAS HELP TO ABSORB WATER RUNOFF WHILE THE RAISED PLANTING AREAS AND BENCHES HELP GIVE THE SPACE STRUCTURE.

SECOND FLOOR GARDEN. NOT ACCESSIBLE CANTILEVERED ENTRANCE CONCEPT 1 - VIEW CONCEPT 1 - VIEW

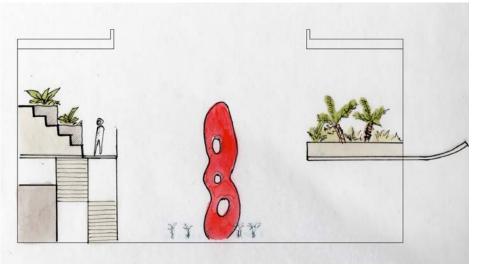










CONCEPT 2 - CONTEMPLATION

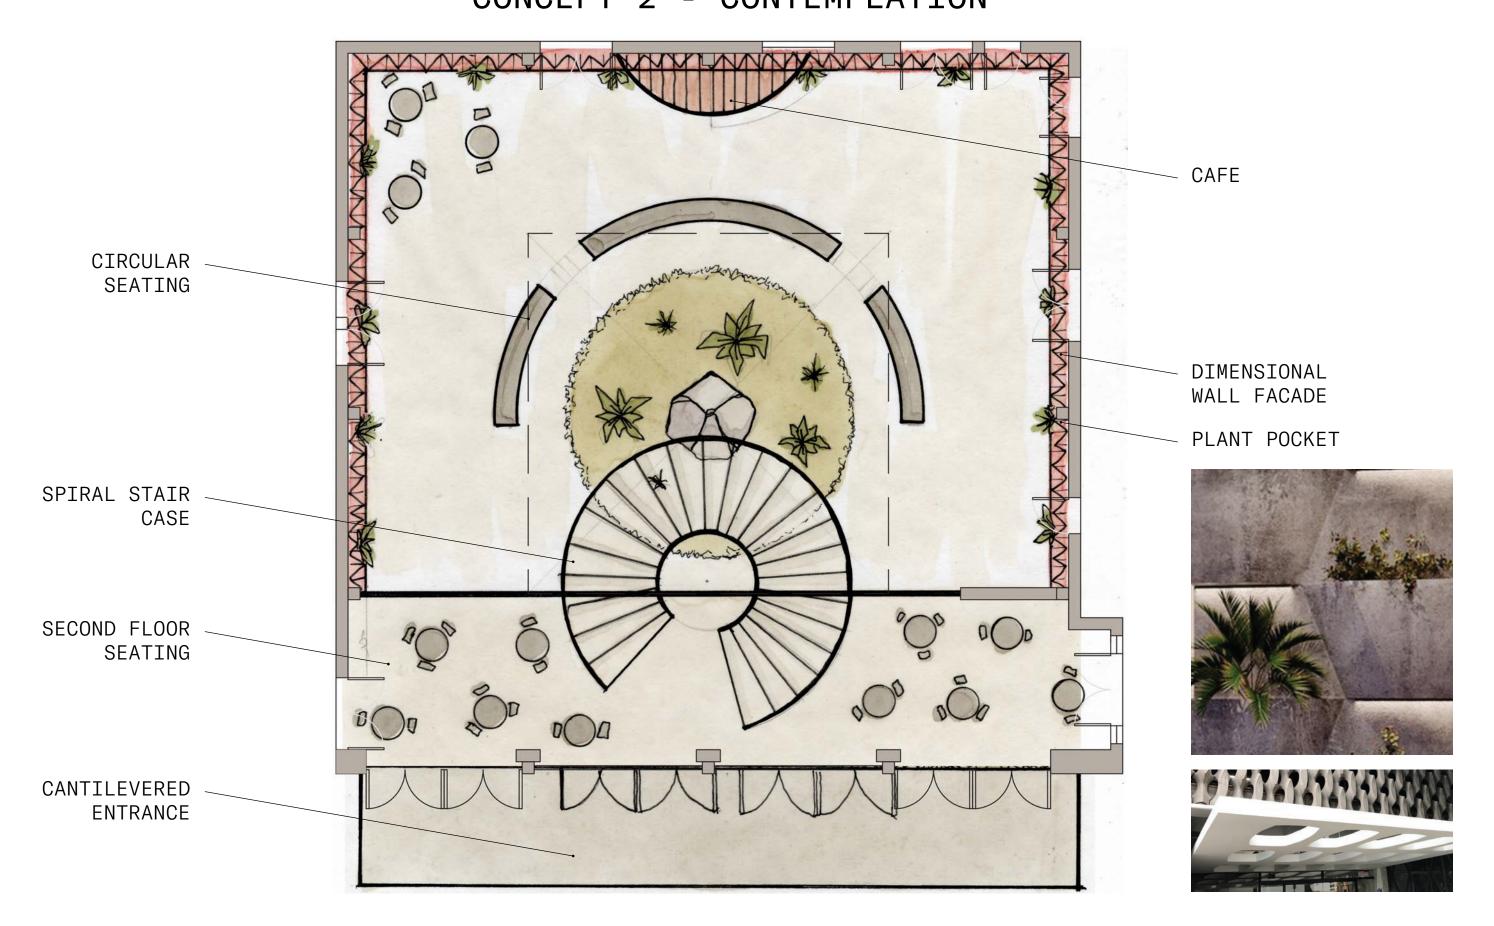

CONCEPT 3 - RESPONSE

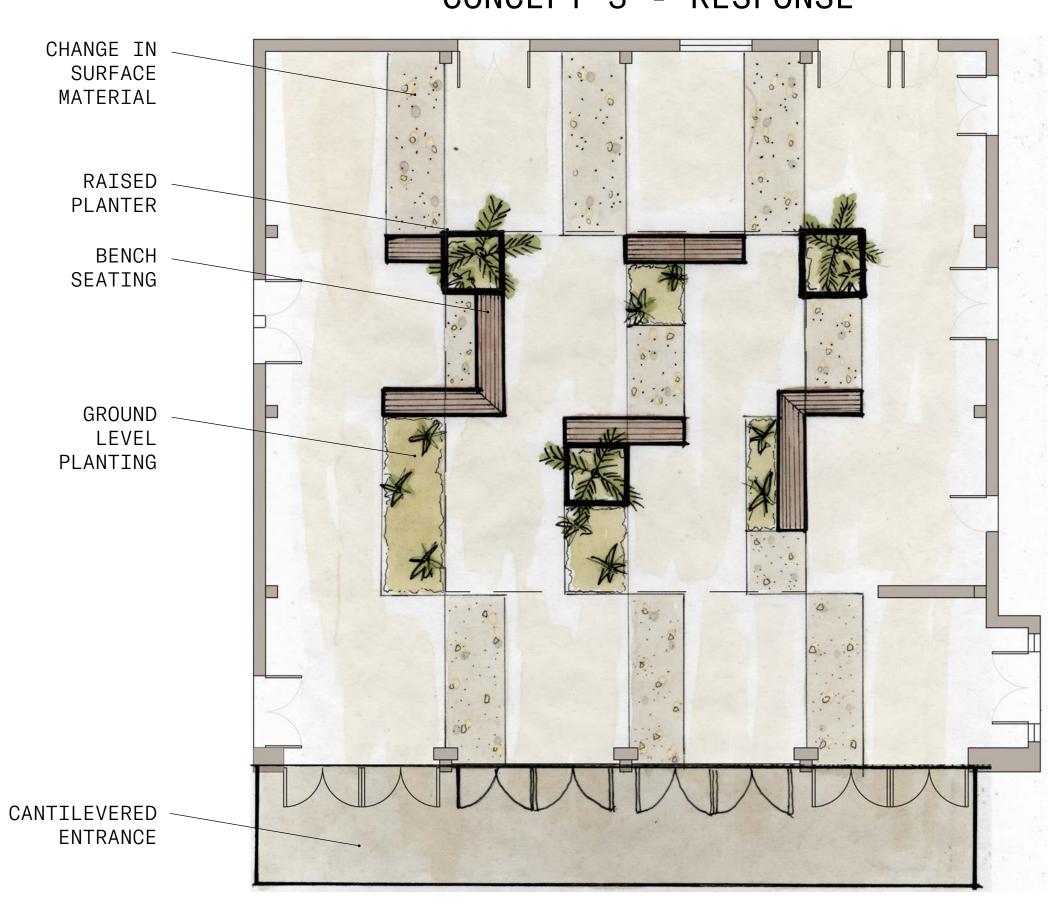

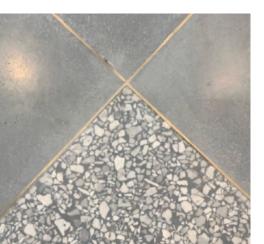







STUDENT NAME BRENNAN GROH

course
LANDSCAPE DESIGN 1

INSTRUCTOR
STEVEN CHAVEZ

SITE NAME AND ADDRESS


MACGOWAN HALL COURTYARD


245 CHARLES E YOUNG DR E, LOS ANGELES, CA 90095

DRAWING TITLE

THREE DESIGN ALTERNATIVES

AERIAL IMAGE

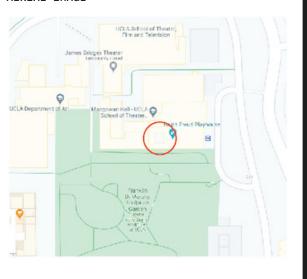

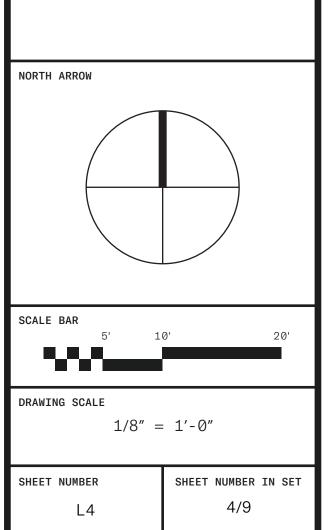

FINAL SITE PLAN



MODULAR TABLES FOR FLEXIBLE PROGRAMMING

CAST IN PLACE

CONCRETE BENCHES TIE

PEDESTRIAN CIRCULATION

CREATING STRUCTURE

AND DIRECTION FOR

THE GRID TOGETHER WHILE

PLANTING POCKETS ON PERIMETER FOR CLIMBING PLANTS TO HELP ABSORB SOUND AND PROVIDE VISUAL INTEREST



A CAFE WINDOW BRINGS A SOCIAL ELEMENT TO THE SPACE AND AN AMENITY FOR VISITORS OF THE THEATERS AND ITS



SPACES

LARGE RAISED PLANTERS CREATE RHYTHM IN THE SPACE AND ELEVATE THE PLANTING, BRINGING THE EYE UPWARD TO THE SKY




SHIFTS IN FLOOR MATERIAL DEFINE THE GRID AND PROVIDE VISUAL INTEREST UNDERFOOT



A LOWER, PERFORATED, CANTILEVERED AWNING DRAWS ATTENTION TO THE ENTRANCE, INVITES PEOPLE IN, AND ENCOURAGES THEM TO PASS THROUGH THE SPACE

IN-FLOOR LIGHTING, NOT SHOWN, DRAWS ATTENTION TO THE ENTRANCE AND CREATES A NIGHT SKY EFFECT

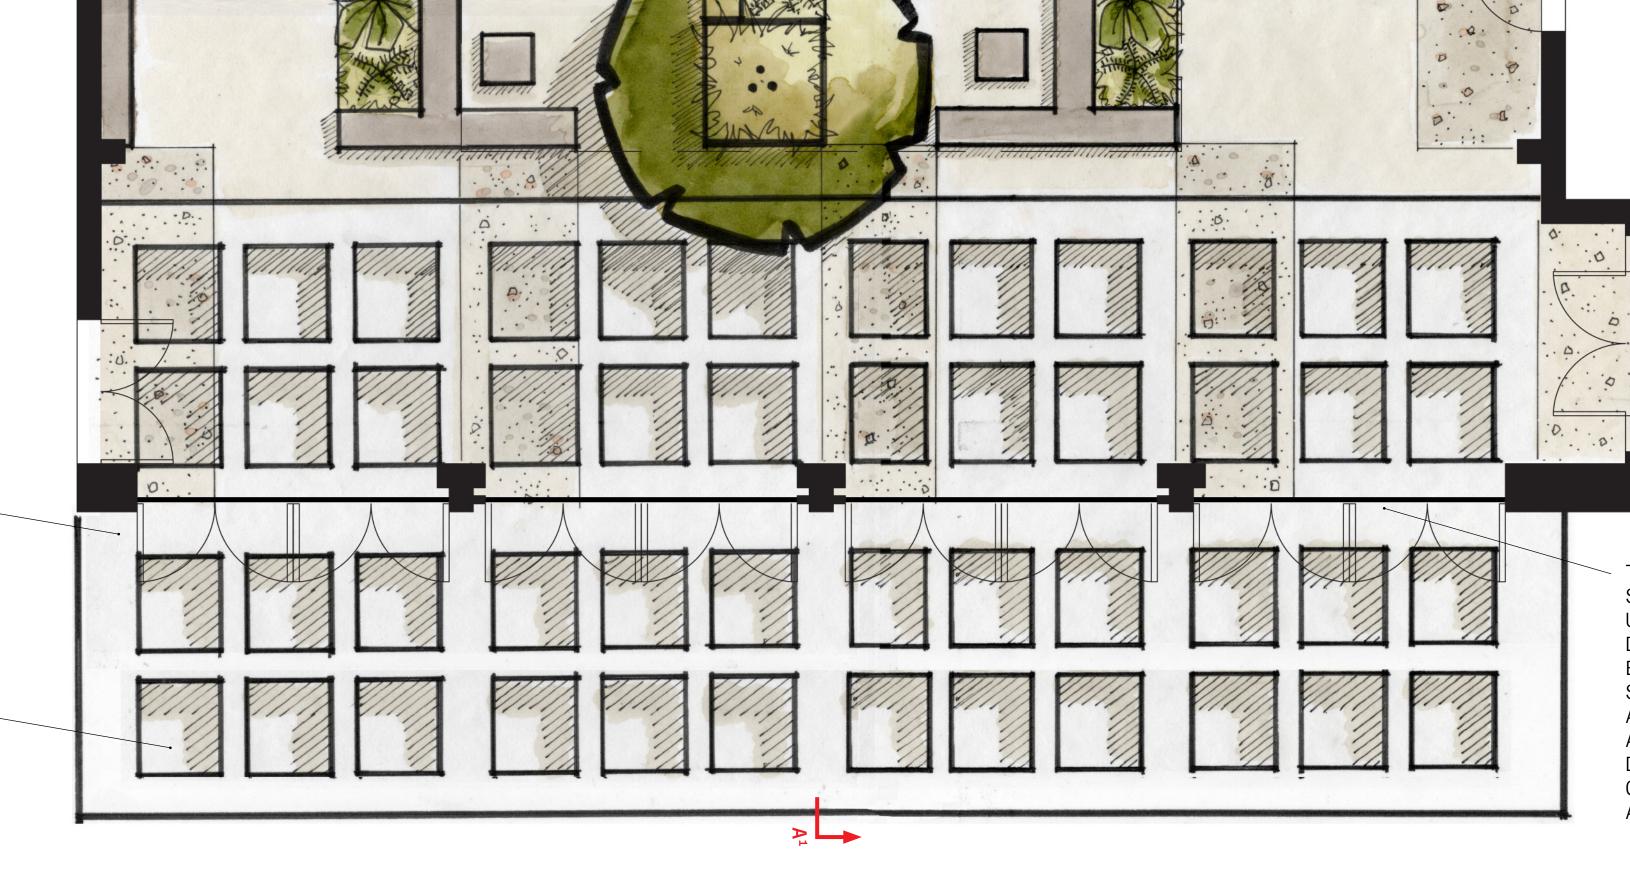

THE LOWER PART OF THE SCRIM IS REMOVED AND UPDATED WITH GLASS DOORS THAT PROVIDE A BETTER VIEW TO THE SCULPTURE GARDEN, SERVE AS A BARRIER FOR WIND, AND CAN BE USED TO DIRECT PEDESTRIAN CIRCULATION BEFORE AND AFTER PERFORMANCES

BRENNAN GROH

LANDSCAPE DESIGN 1

STEVEN CHAVEZ

INSTRUCTOR

STUDENT NAME

SITE NAME AND ADDRESS MACGOWAN HALL COURTYARD

245 CHARLES E YOUNG DR E, LOS ANGELES, CA 90095

DRAWING TITLE

FINAL SITE PLAN




RESPONSE IS A DESIGN THAT TAKES ITS CUE FROM THE ARCHITECTURE THAT SURROUNDS THE SPACE, HONORING ITS 1960S ROOTS WHILE UPDATING IT TO ADDRESS THE NEEDS OF ITS VISITORS THROUGH HONEST MATERIALS AND SYMPATHETIC | FORMS AND PLANTING.

THE UNDERLYING LAYOUT OF THE SPACE IS BASED ON A GRID TAKEN FROM THE VERTICAL SUPPORTS ON EACH WALL AND INSPIRED BY THE PRESERVED SCRIM THAT COVERS THE FACADE. THE GRID IS DEFINED BY SHIFTS IN FLOOR MATERIAL AND IN-GROUND PLANTING BEDS. STRUCTURE IS CREATED WITH CAST IN PLACE CONCRETE BENCHES AND LARGE RAISED PLANTERS THAT PLAY WITH THE IDEA OF EXTRUDED FORMS FROM THE GRID.

THIS NEW DESIGN WILL NOT ONLY FUNCTION WELL ON PERFORMANCE NIGHTS BY ADDRESSING PEDESTRIAN CIRCULATION CHALLENGES, BUT IT WILL ALSO SERVE AS AN INVITING AND USABLE SPACE FOR STUDENTS AND TEACHERS DURING THE DAY.

SEE ADDITIONAL DESIGN NOTES ON THE LEFT.

NORTH ARROW

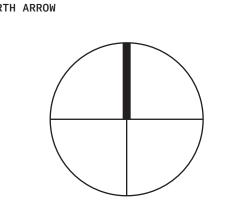

DRAWING SCALE

1/4" = 1'-0"

SHEET NUMBER IN SET SHEET NUMBER 5/9 L5


SECTION ELEVATION A




PERSPECTIVE (NTS)



SECTION ELEVATION B

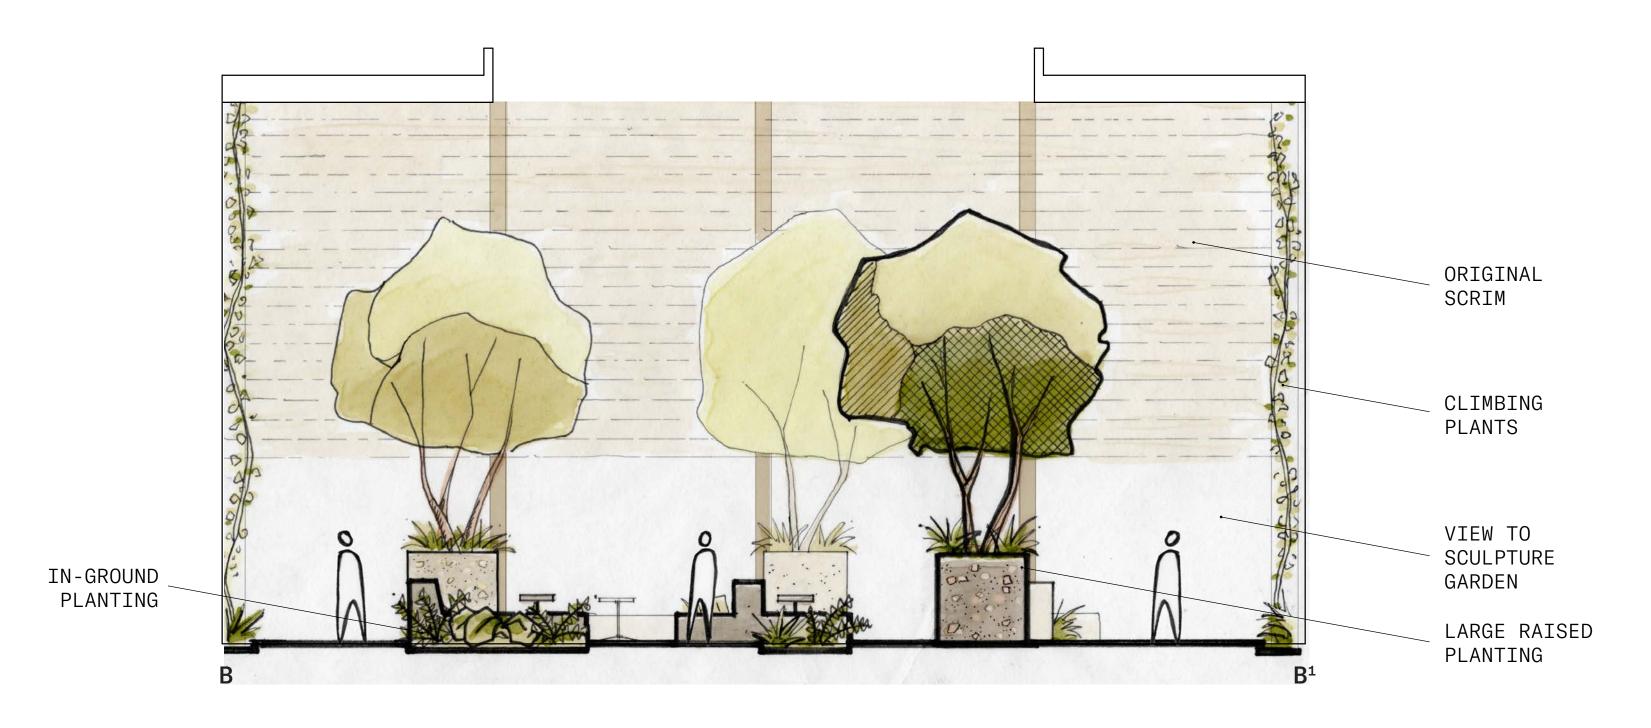

KEY MAP (NTS)

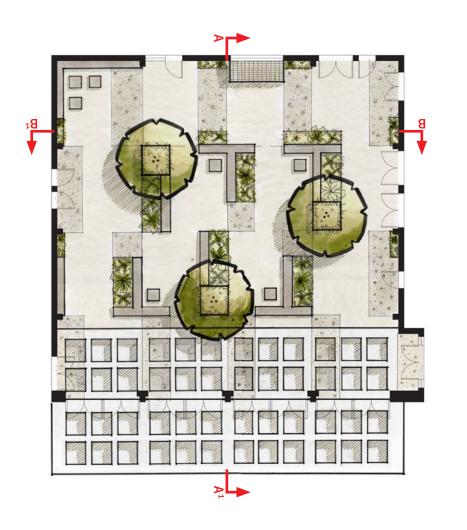

STUDENT NAME

BRENNAN GROH

LANDSCAPE DESIGN 1

INSTRUCTOR

STEVEN CHAVEZ


SITE NAME AND ADDRESS MACGOWAN HALL COURTYARD UCLA

245 CHARLES E YOUNG DR E, LOS ANGELES, CA 90095

DRAWING TITLE

SECTION ELEVATIONS AND PERSPECTIVE DRAWING



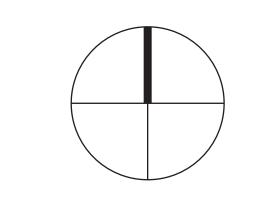

DRAWING SCALE 3/16" = 1'-0"

SHEET NUMBER IN SET











STUDENT NAME

BRENNAN GROH

OUDOE

LANDSCAPE DESIGN 1

27111000

INSTRUCTOR
STEVEN CHAVEZ

SITE NAME AND ADDRESS

MACGOWAN HALL COURTYARD UCLA

245 CHARLES E YOUNG DR E, LOS ANGELES, CA 90095

DRAWING TITLE

PHYSICAL MODEL

AERIAL IMAGE



NORTH ARROW

CALE BAR

DRAWING SCALE


SHEET N


SHEET NUMBER IN SET

L7 7/9





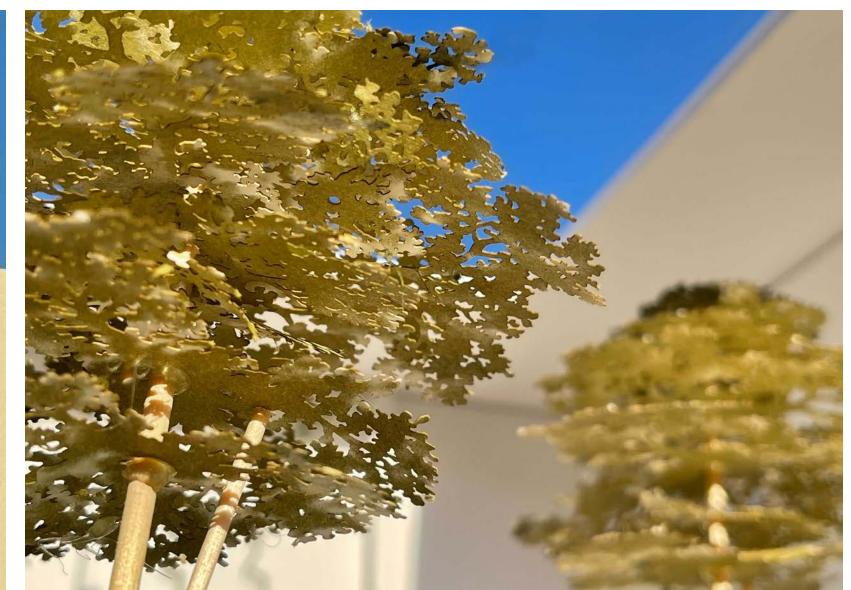

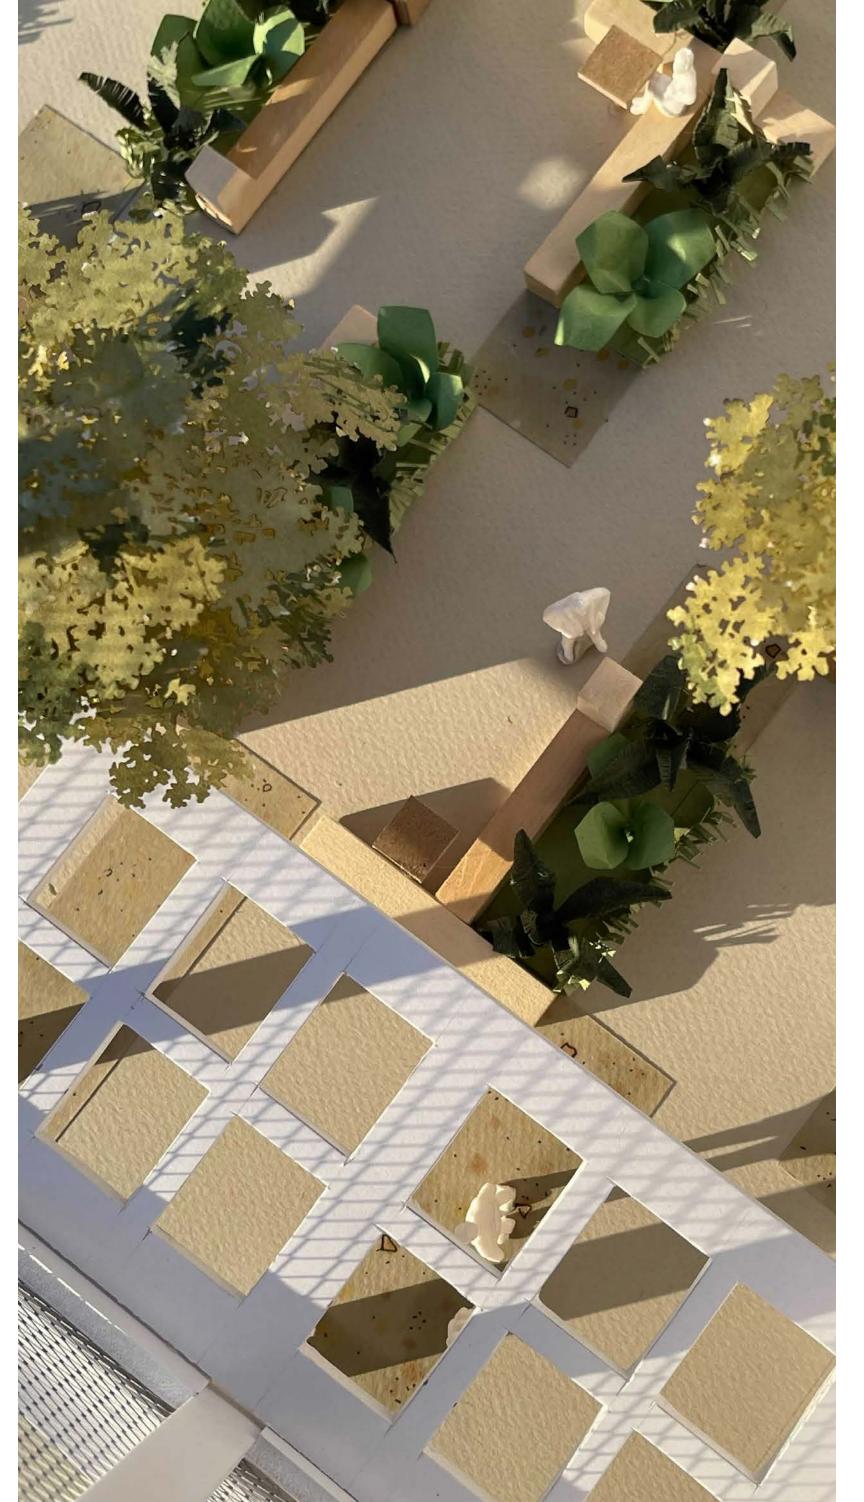

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BRENNAN GROH

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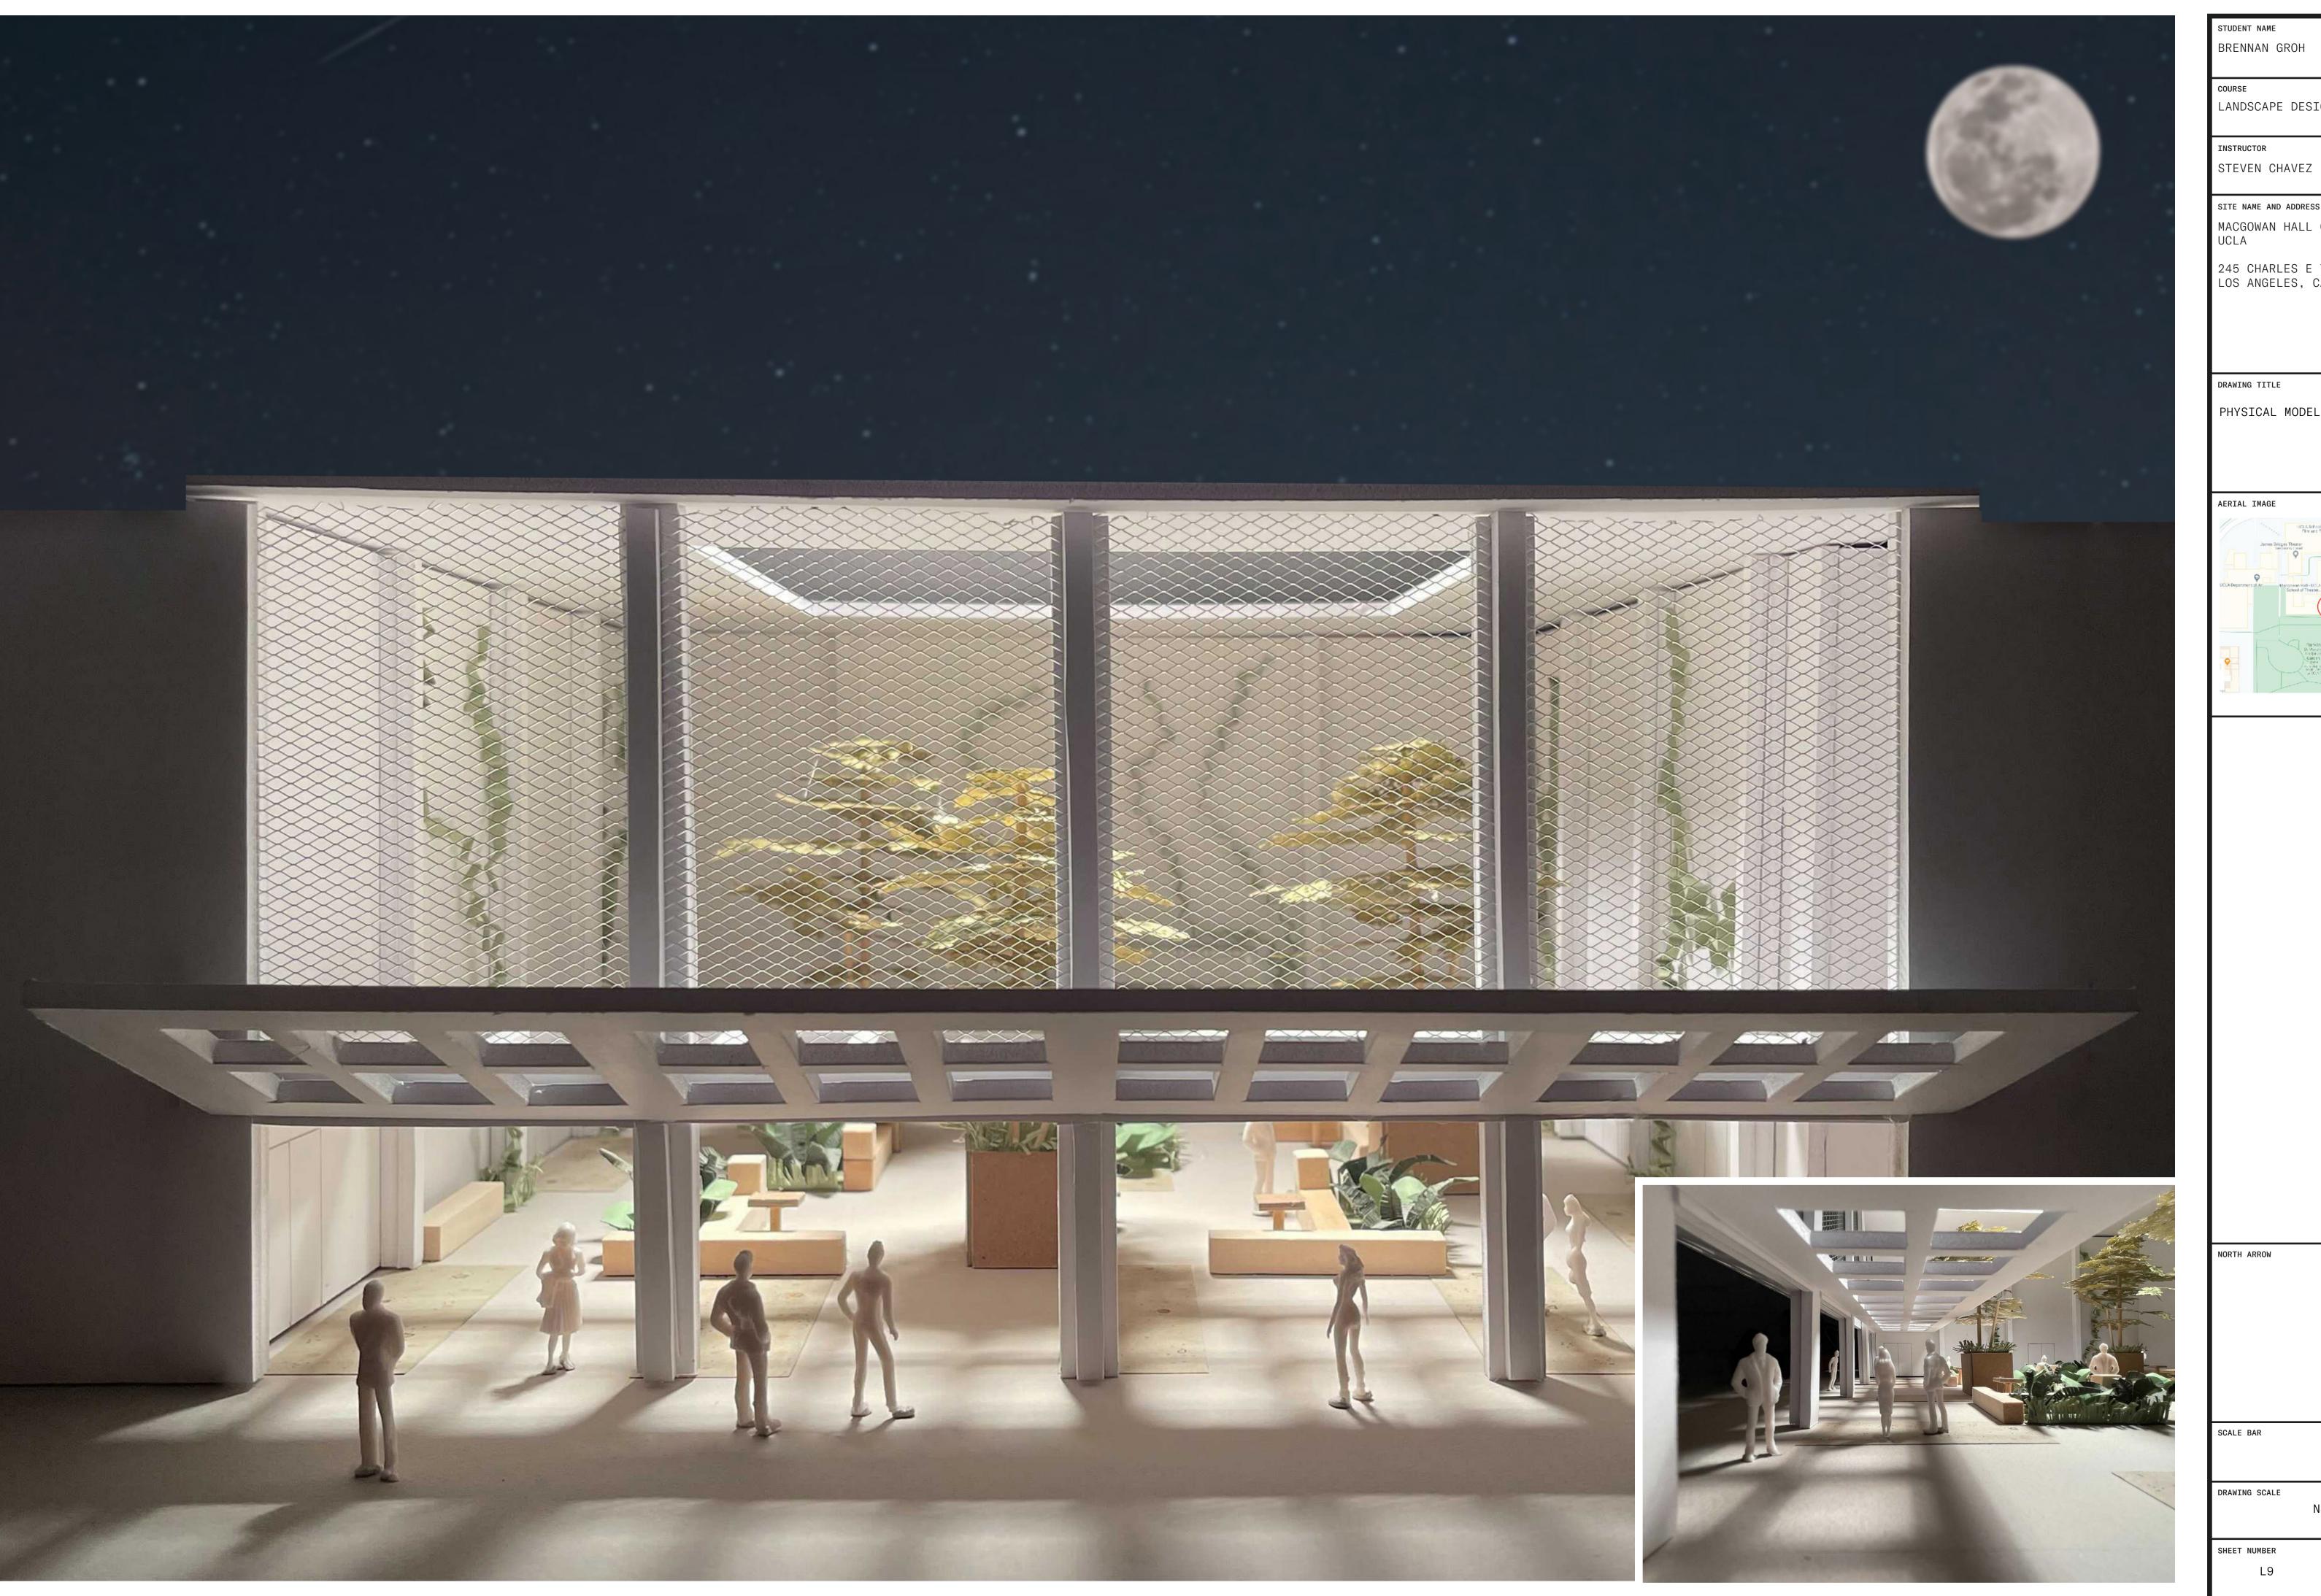
PHYSICAL MODEL



NORTH ARROW

DRAWING SCALE

SHEET NUMBER IN SET



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SITE NAME AND ADDRESS

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PHYSICAL MODEL



NORTH ARROW

DRAWING SCALE

SHEET NUMBER IN SET